ATHLETIC FACILITY IMPROVEMENTS AT AVON HIGH SCHOOL



PREPARED FOR:

TOWN OF AVON 60 WEST MAIN STREET AVON, CT 06001

510 WEST AVON ROAD AVON, CONNECTICUT APRIL 8, 2019



250	0	500	1000	1500 feet
		SCALE: 1"=	500'	

SE-2


- SE-4


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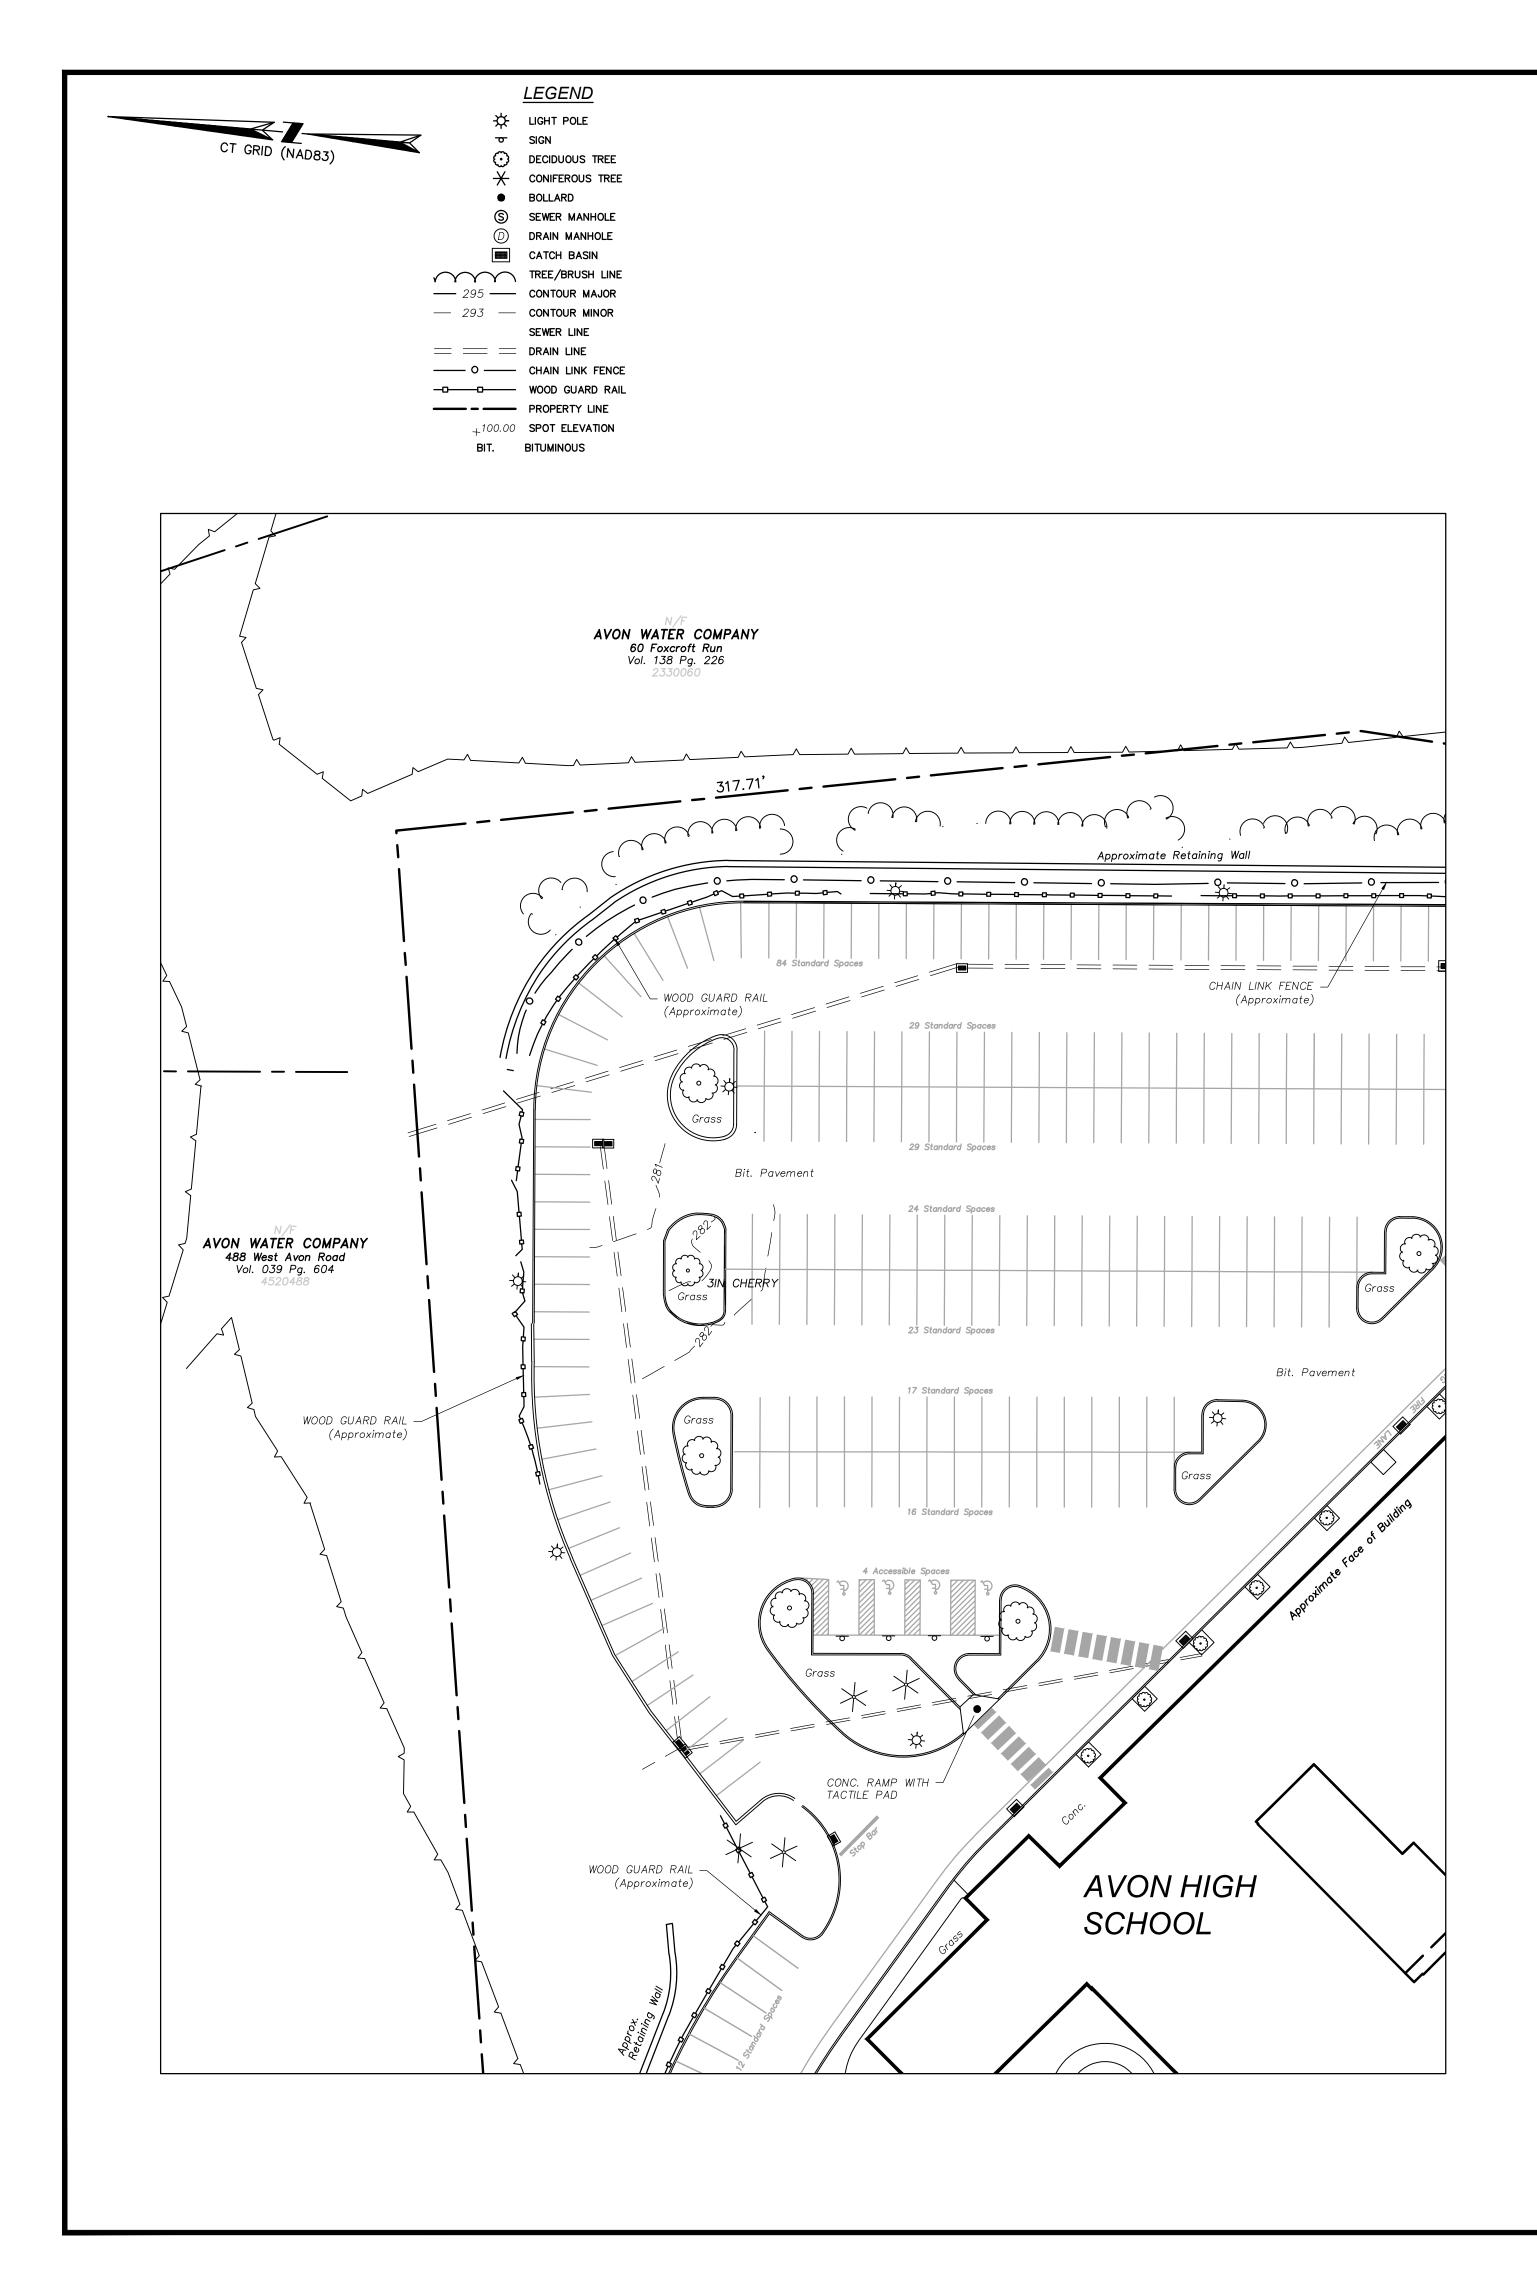
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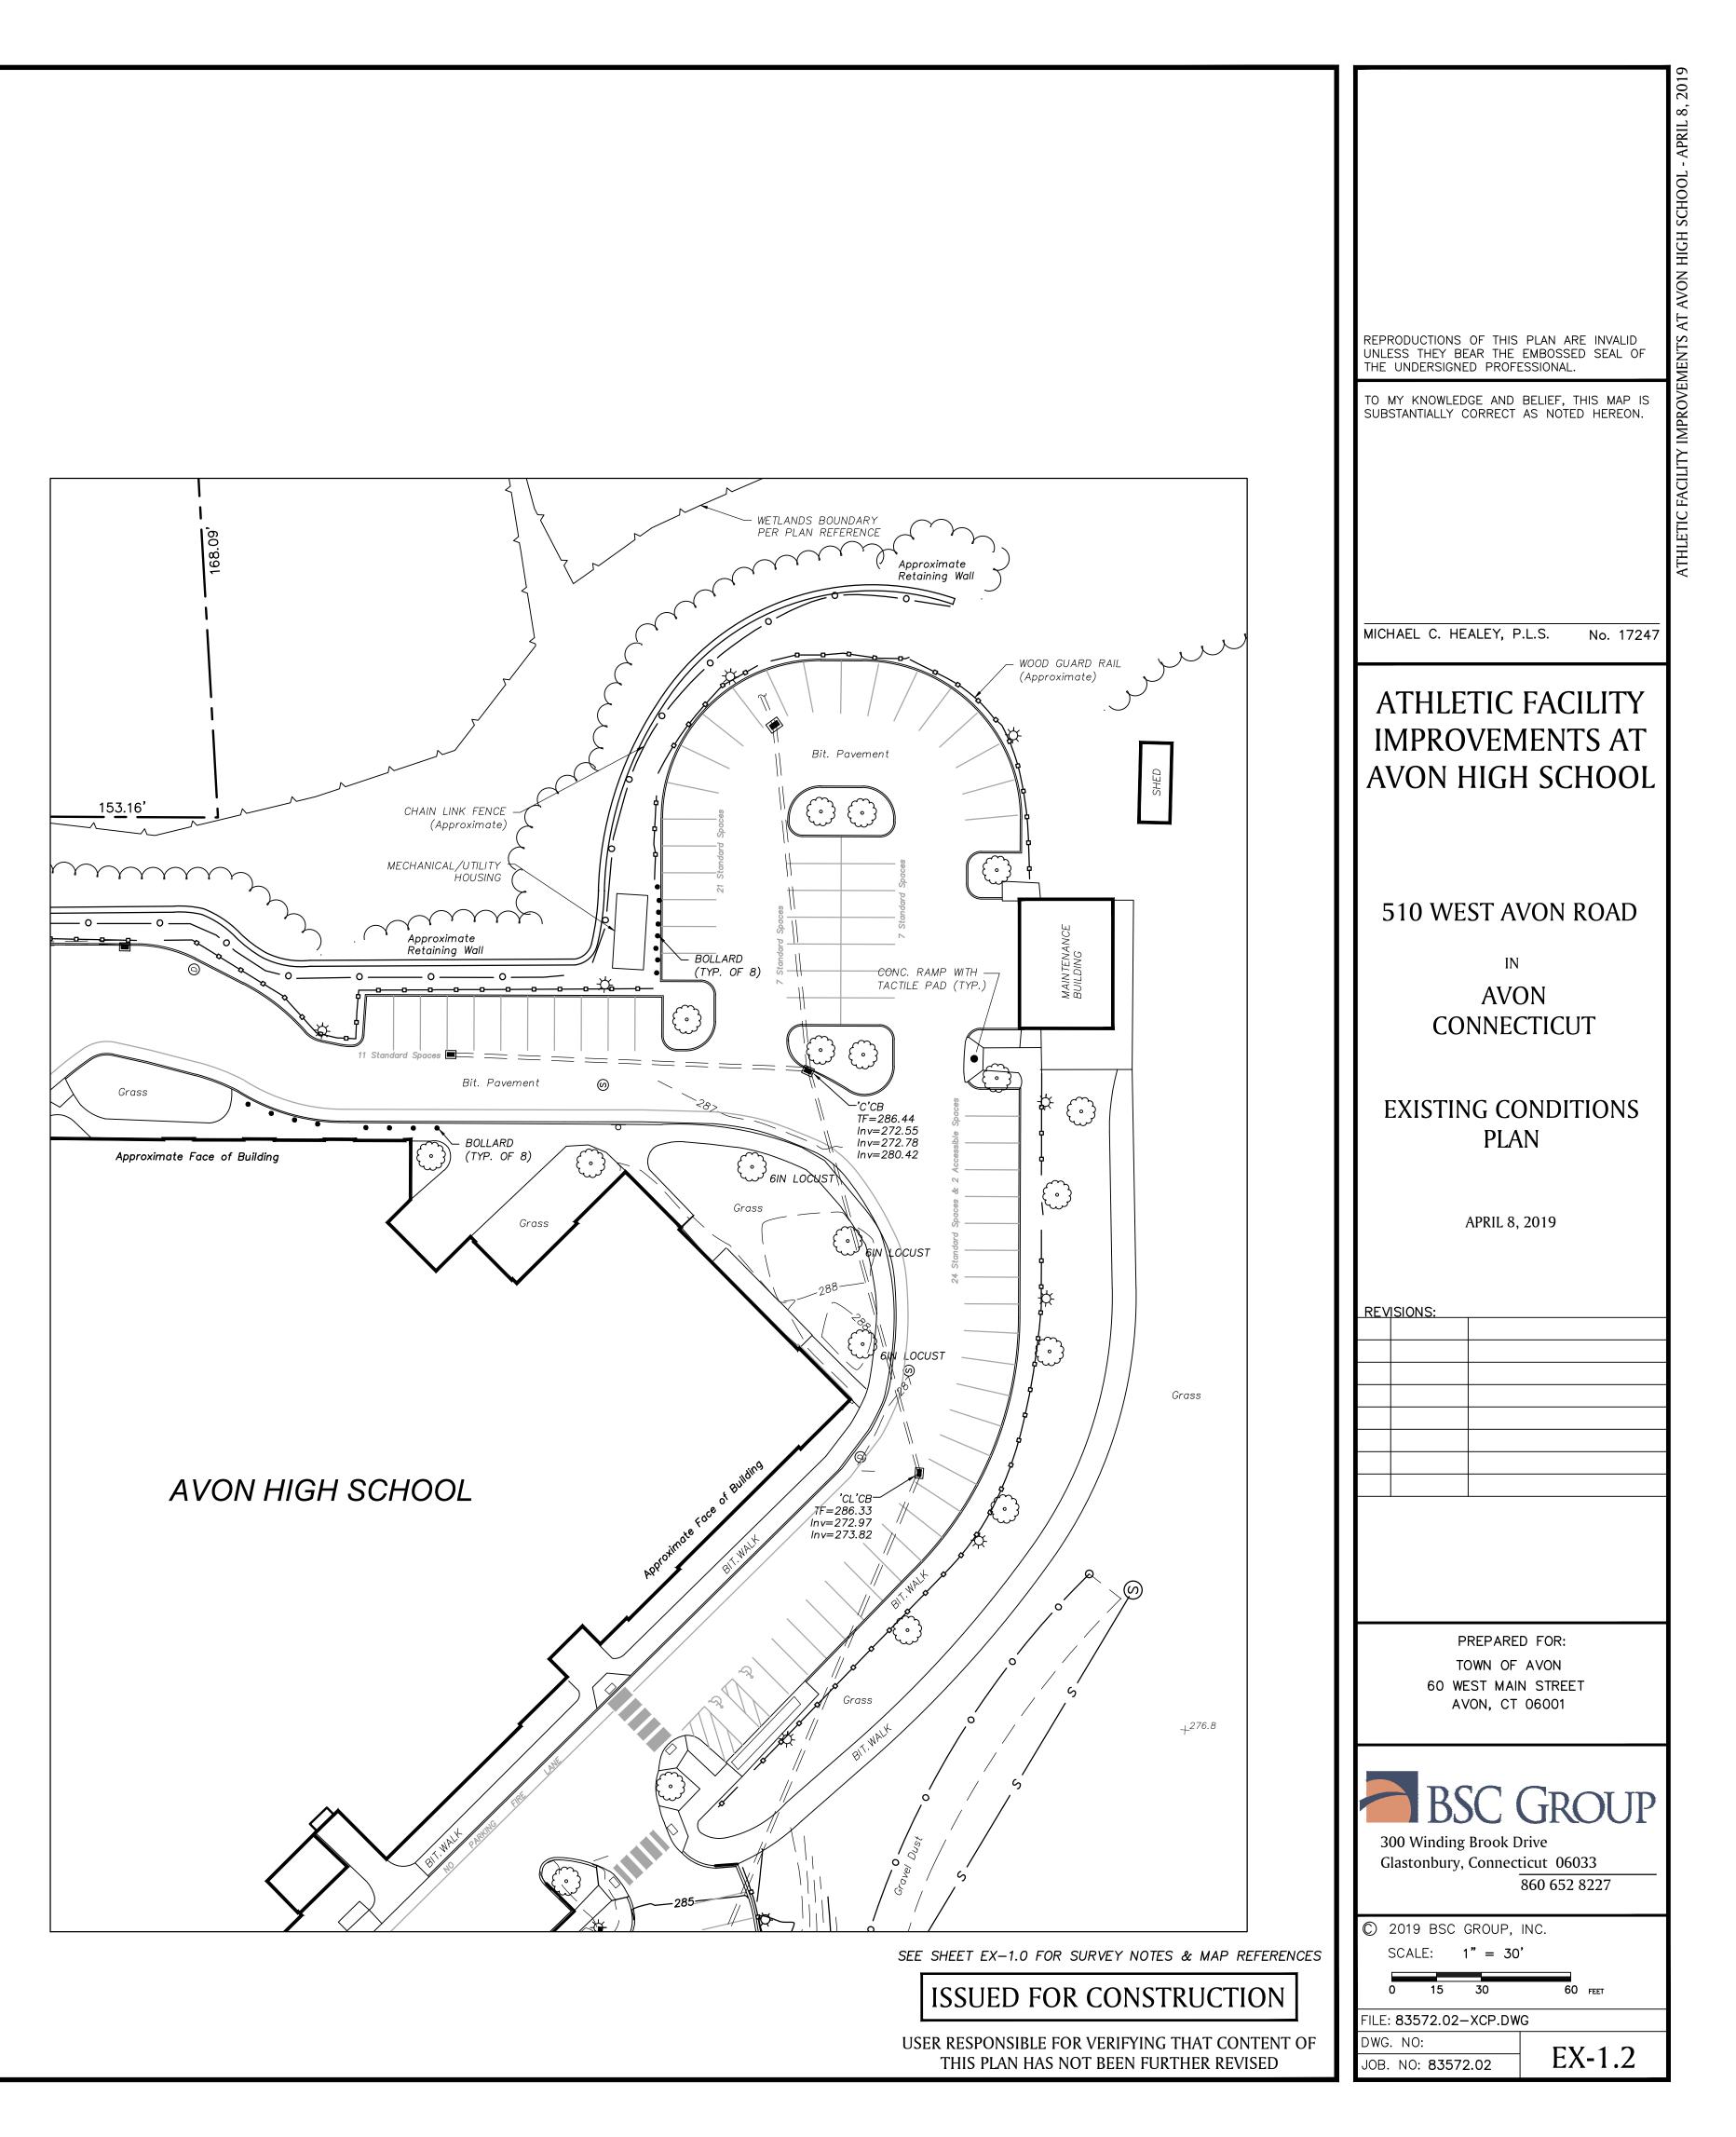
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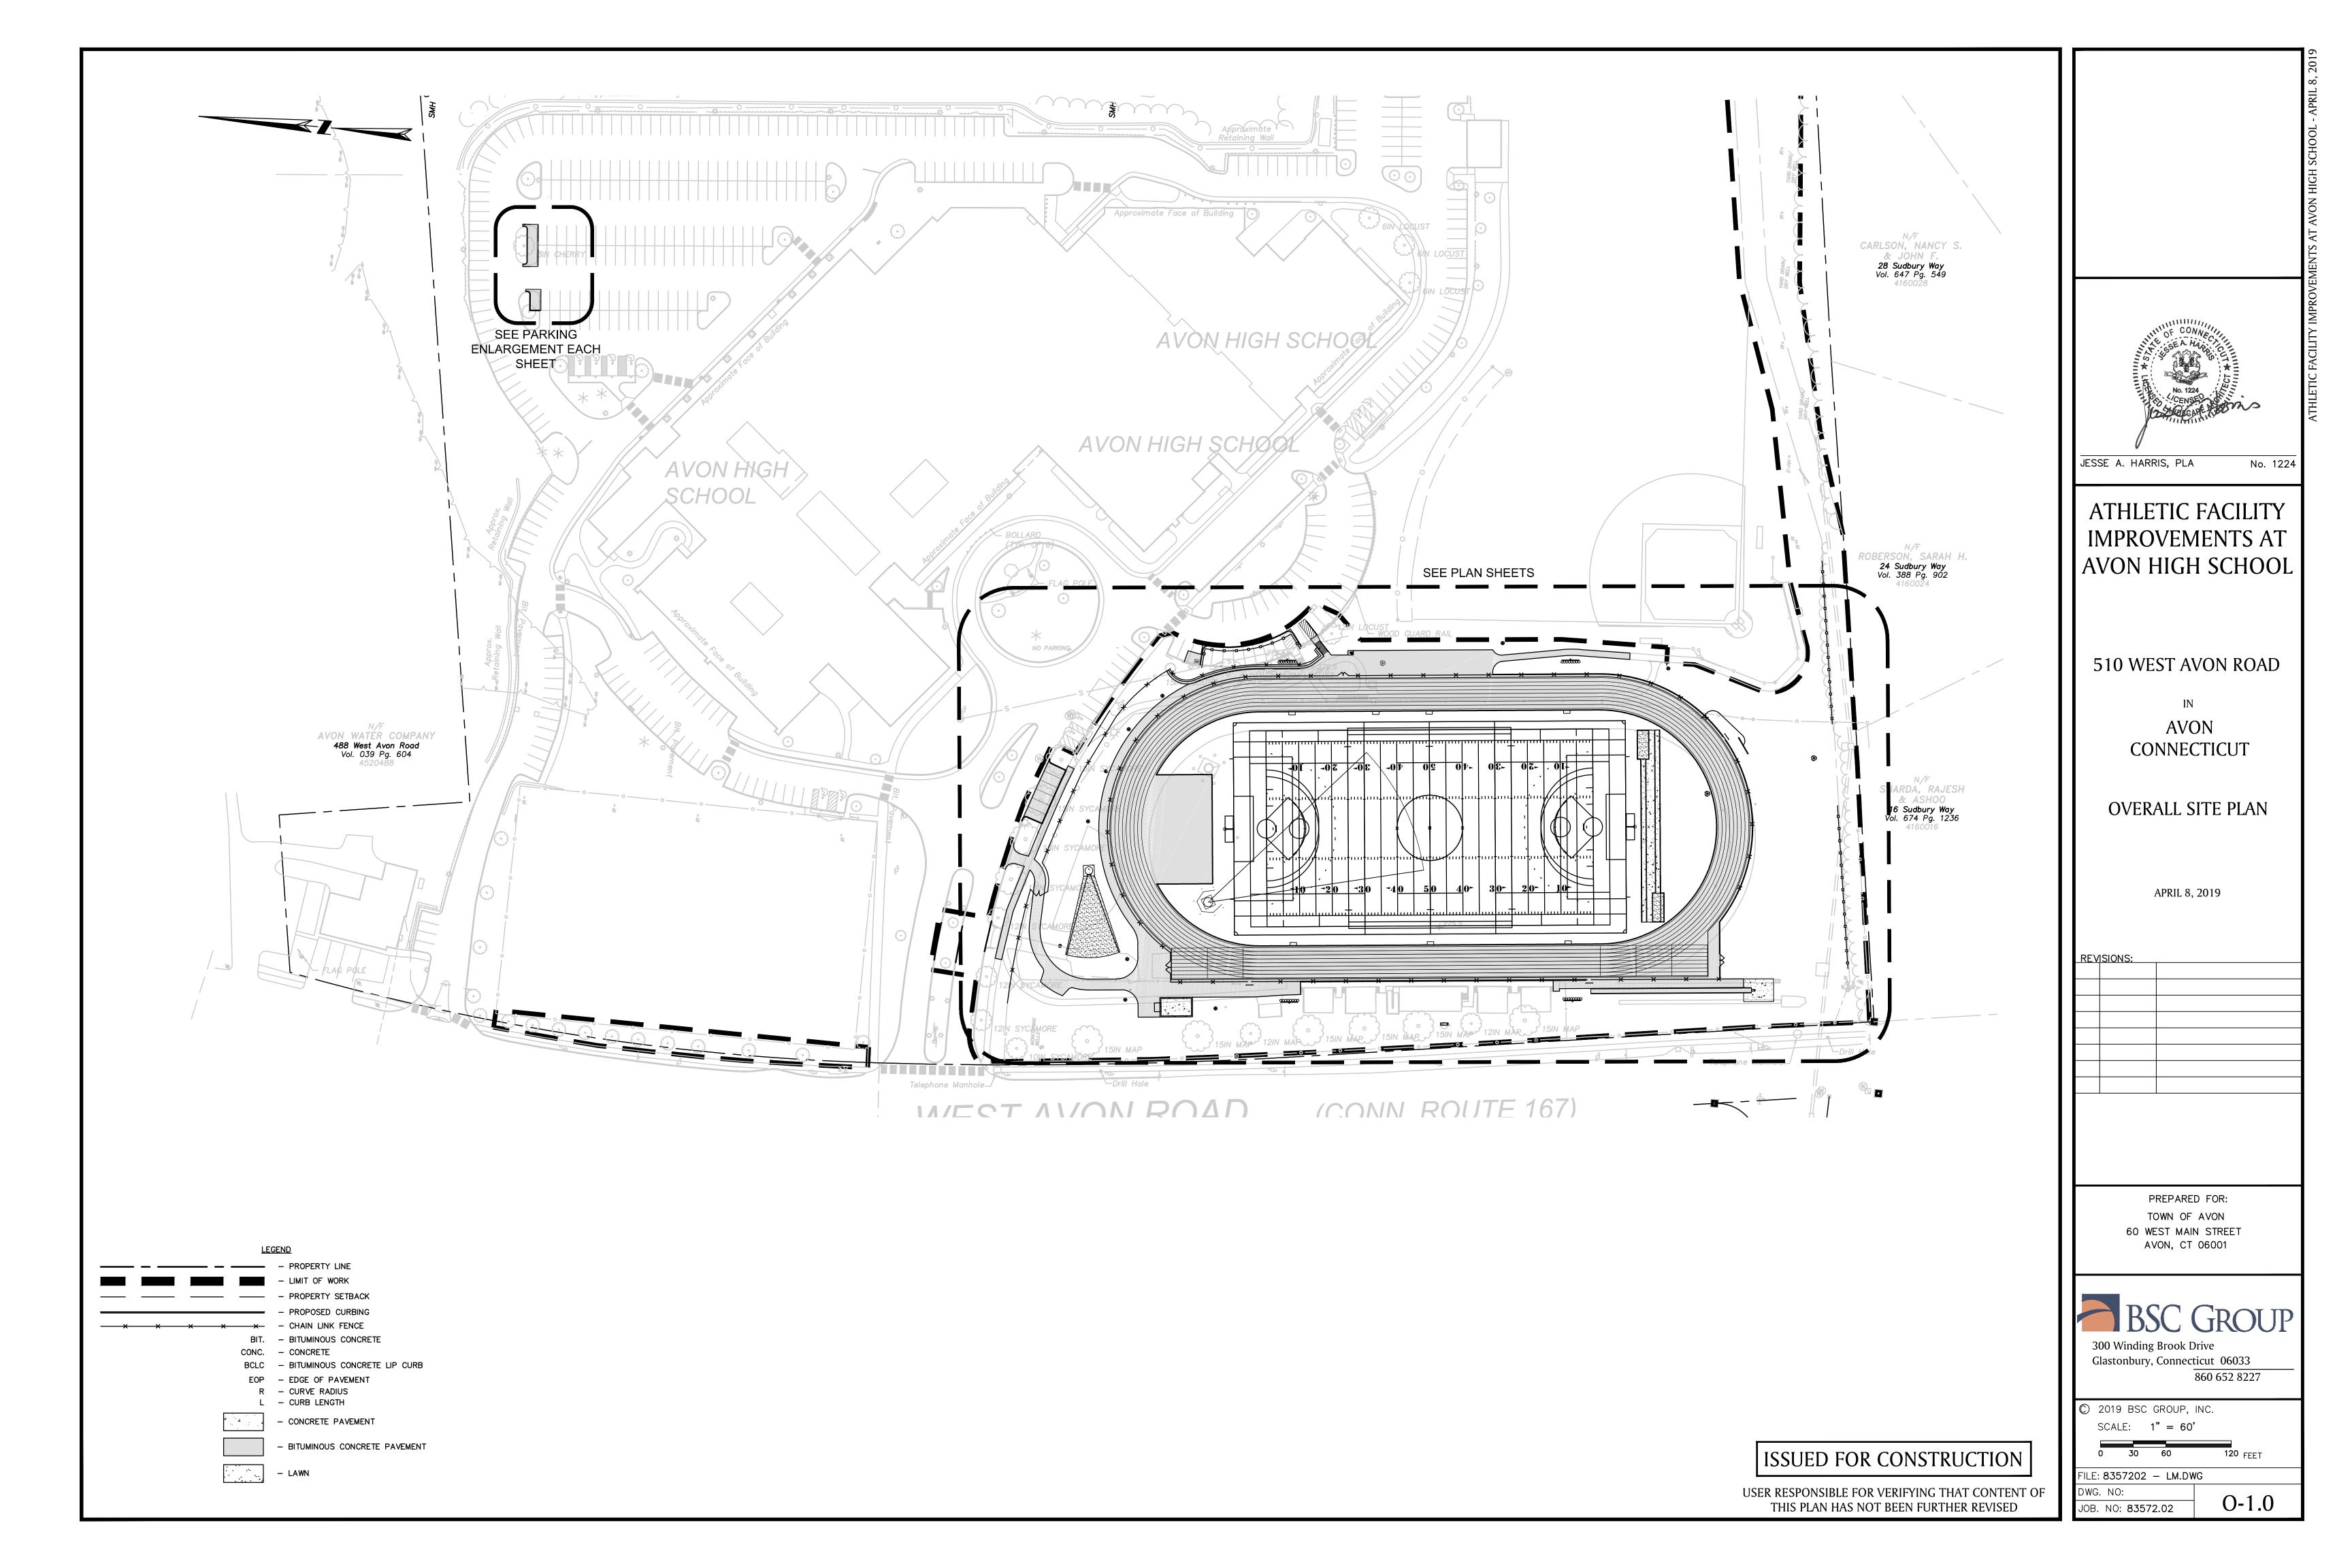
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COVER
T-1.0
EX-1.0 EXISTING CONDITIONS PLAN
EX-1.1 EXISTING CONDITIONS PLAN
EX-1.2 EXISTING CONDITIONS PLAN
0-1.0 OVERALL SITE PLAN
       EROSION AND SEDIMENT CONTROL PLAN
C-2.0 SITE PREPARATION PLAN
       MAINTENANCE AND PROTECTION OF
C-2.1
       TRAFFIC PLAN
       GRADING AND DRAINAGE PLAN
C - 3.0
       ENLARGEMENT
      LAYOUT PLAN
L - 1.0
       TRACK LAYOUT PLAN
      FIELD LAYOUTS
_-1.2
      MATERIALS PLAN
_-2.0
       DETAILS
 -3.0
       DETAILS
 L-3.2 DETAILS
_-3.3 DETAILS
_-3.4
      DETAILS
      DETAILS
 _-3.5
      OVERALL PLANTING PLAN
_-4.0
       PLANTING PLAN ENLARGMENTS
_-4.1
_—4.2 PLANTING PLAN ENLARGEMENTS (CONT.)
       SEGMENTAL RETAINING WALL PLAN,
S-1.0
       ELEVATION AND DETAILS
DSE-1 SITE LIGHTING DEMOLITION PLAN
      SITE LIGHTING PLAN
SE-1
      PHOTOMETRICS PLAN
      SCHEDULES AND DIAGRAMS
SE-3
       DETAILS, SYMBOLS NOTES AND
       ABBREVIATIONS
         PREPARED BY: BSC GROUP
                      300 Winding Brook Drive
                      Glastonbury, Connecticut 06033
                               860 652 8227
                                     SHEET T-1.0
                  JOB NO: 83572.02 DWG NO:
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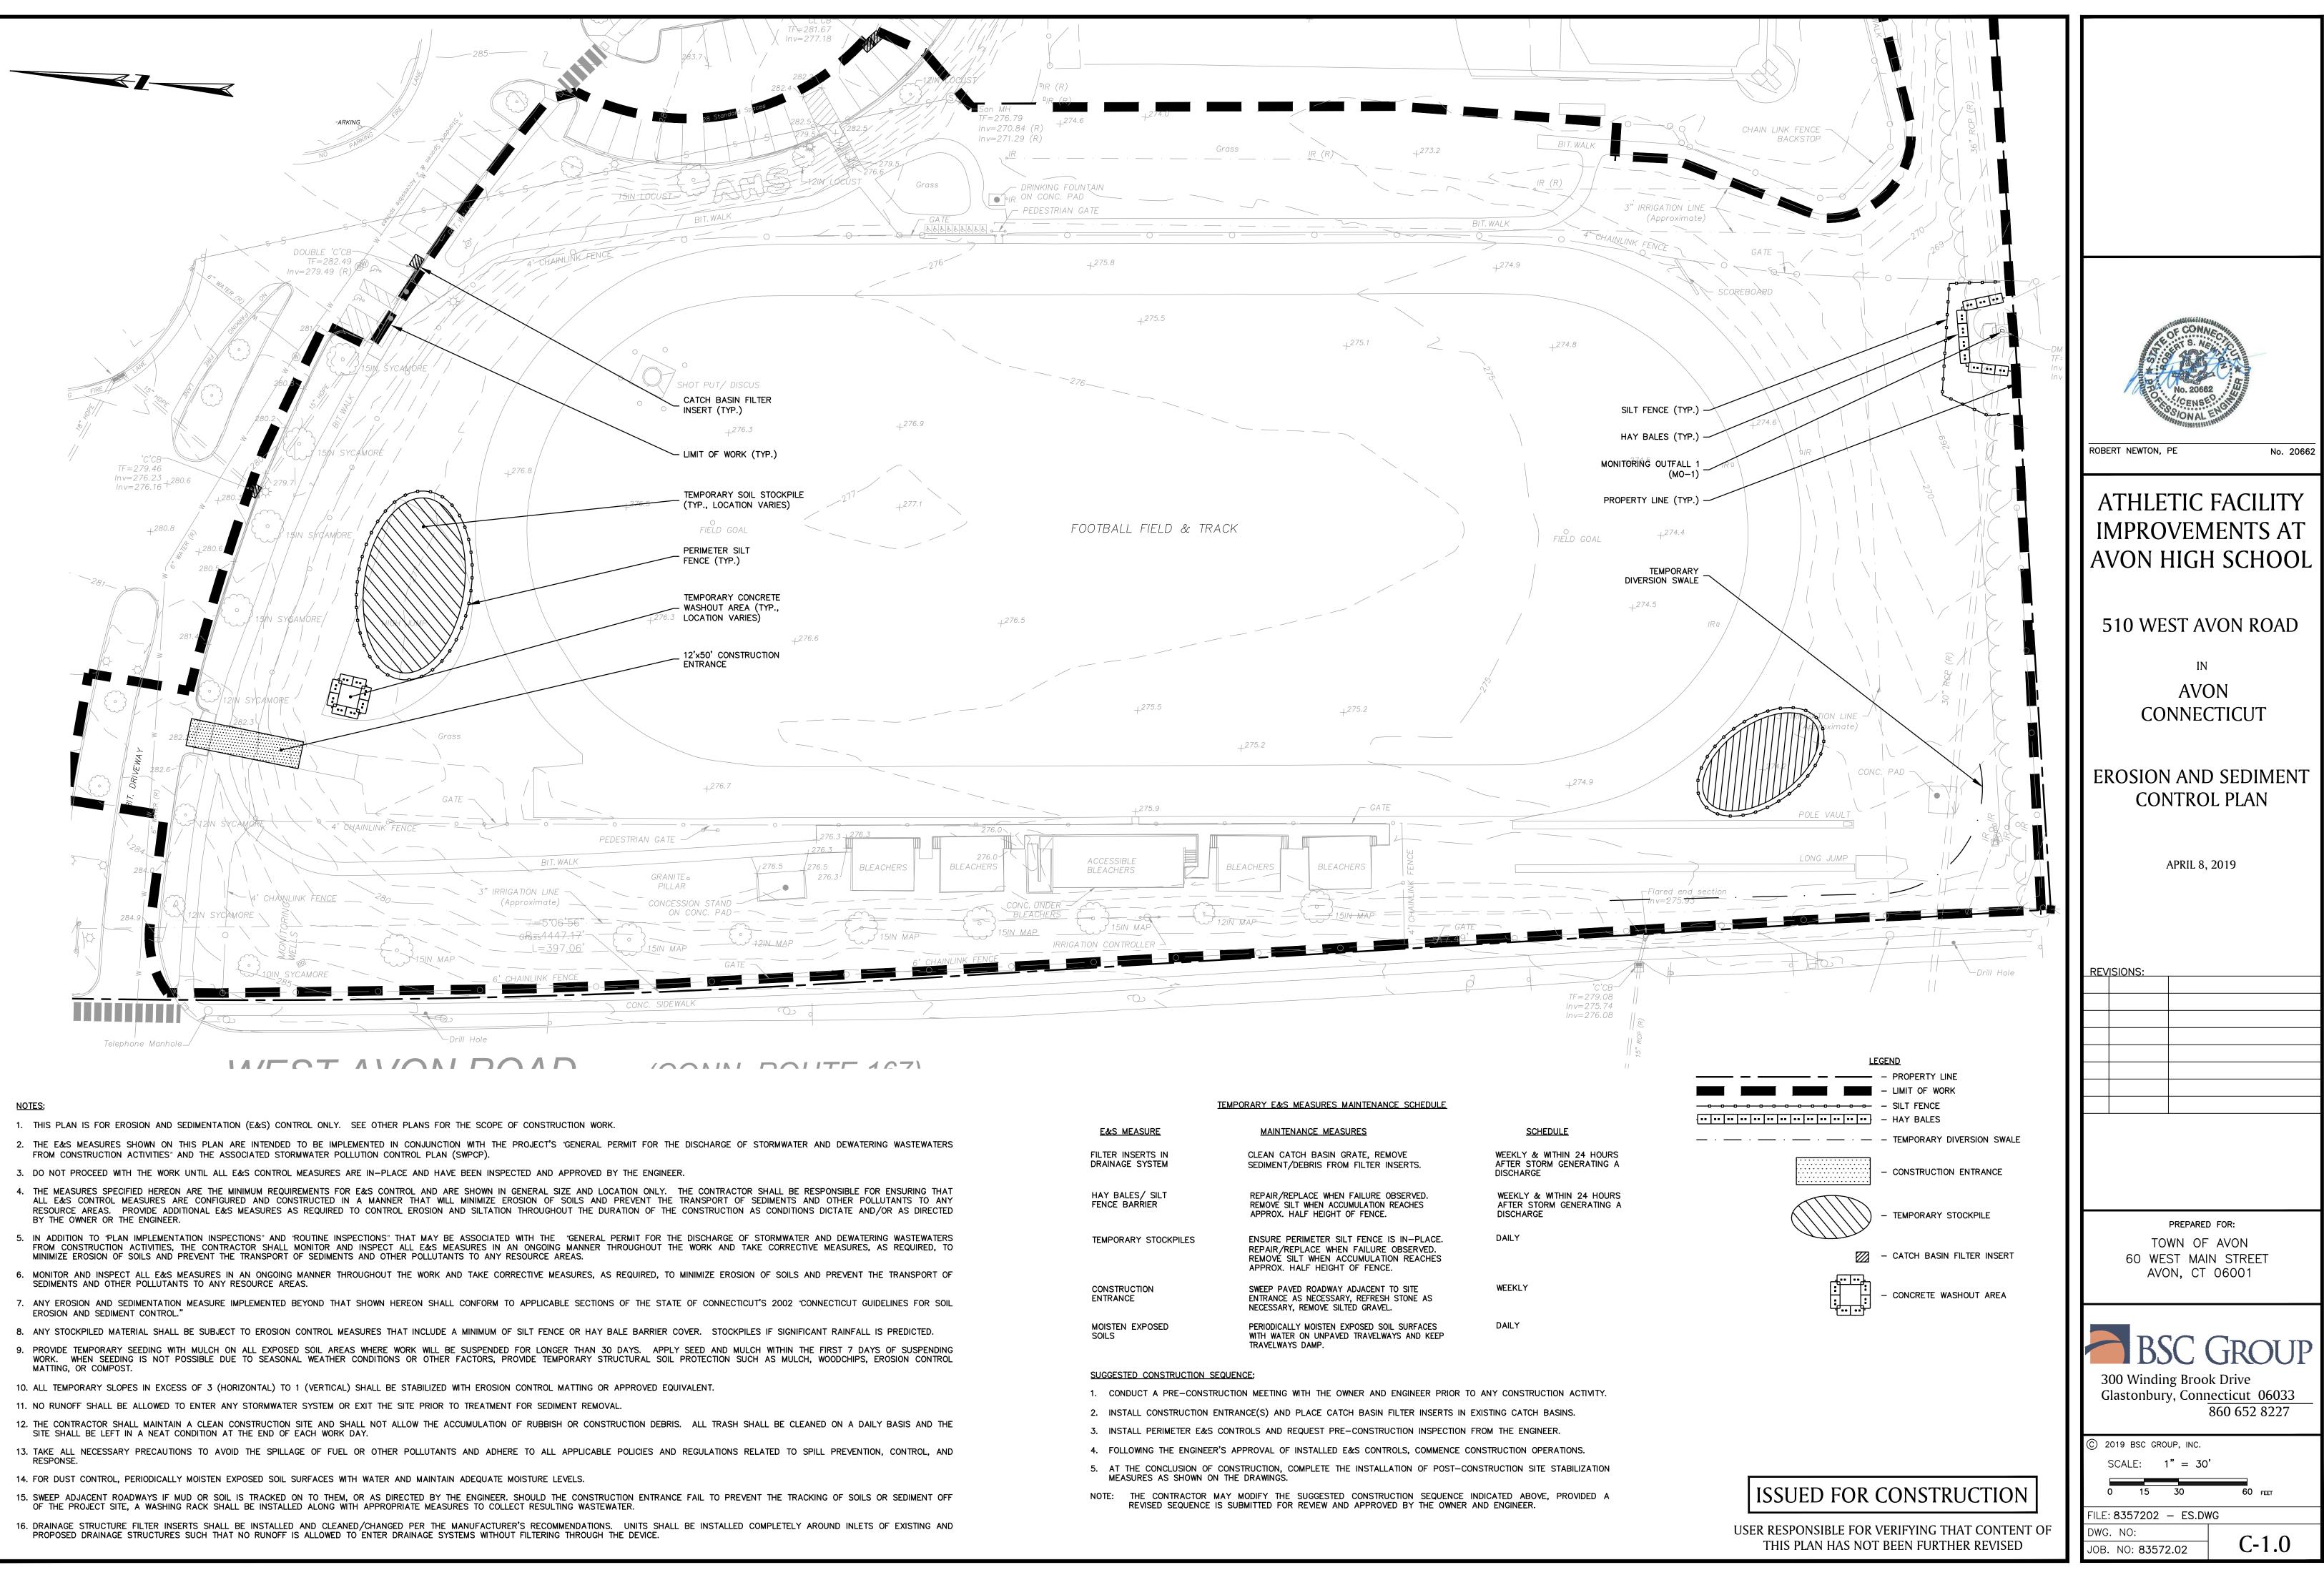










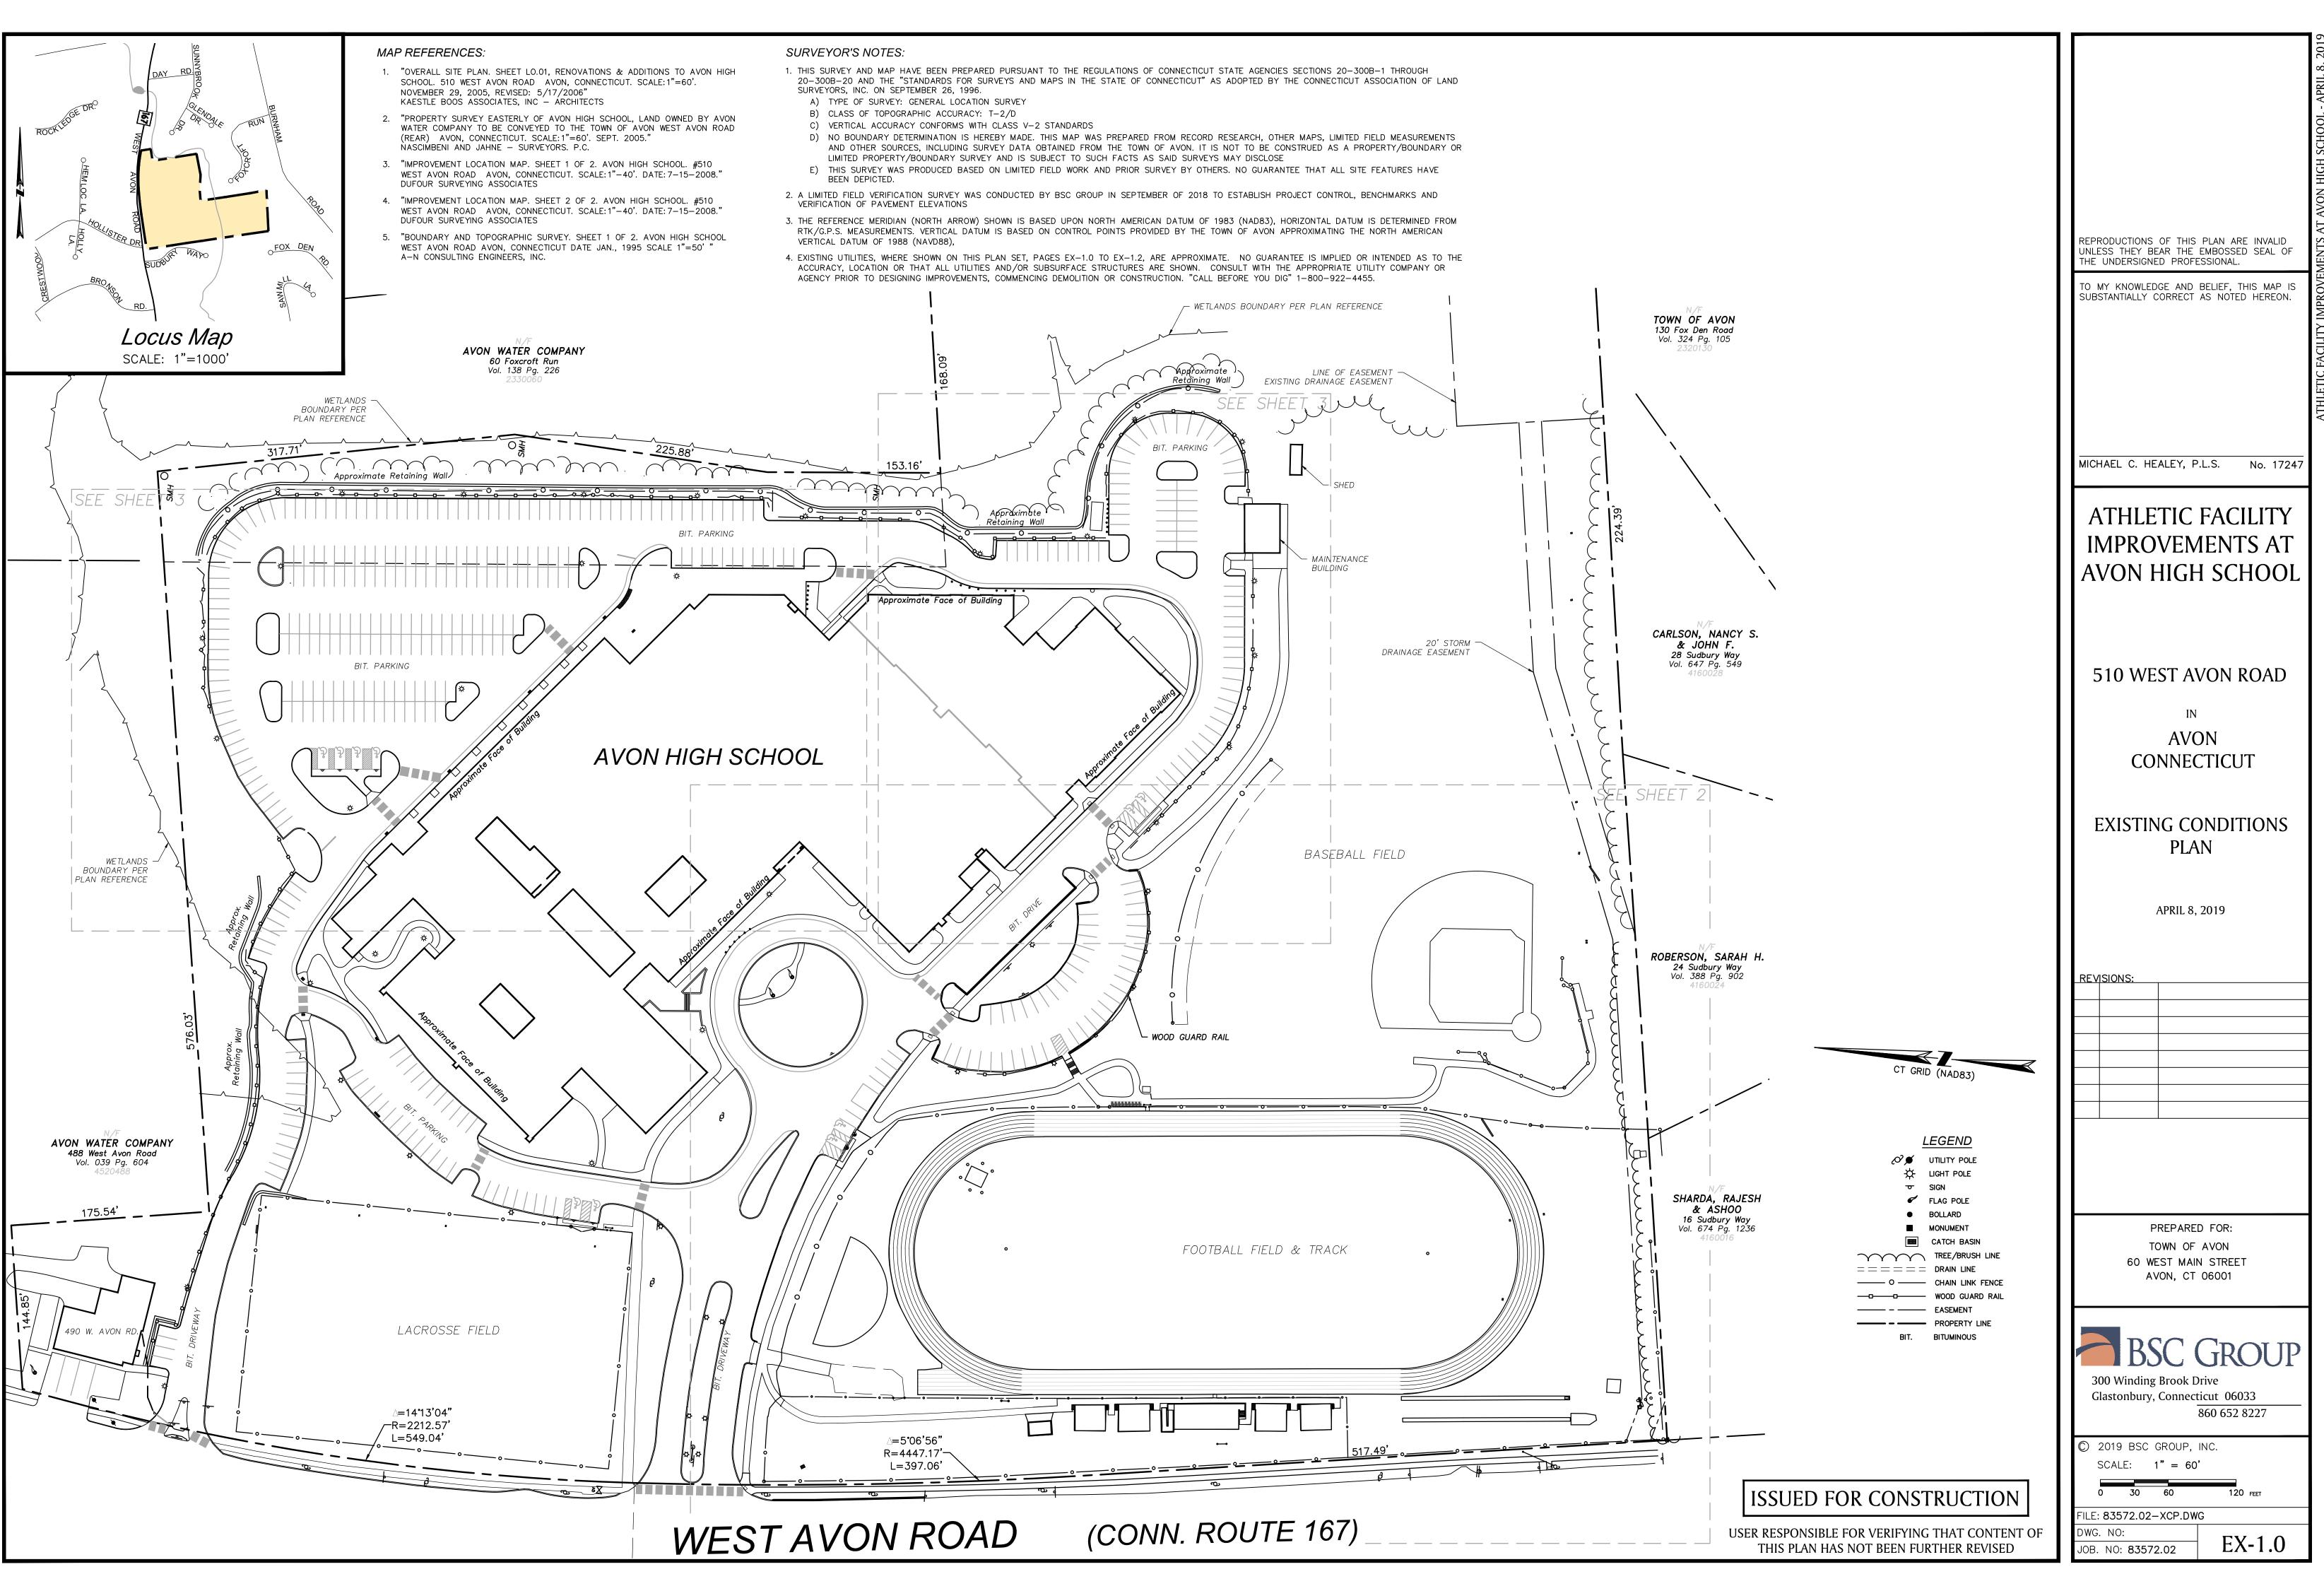


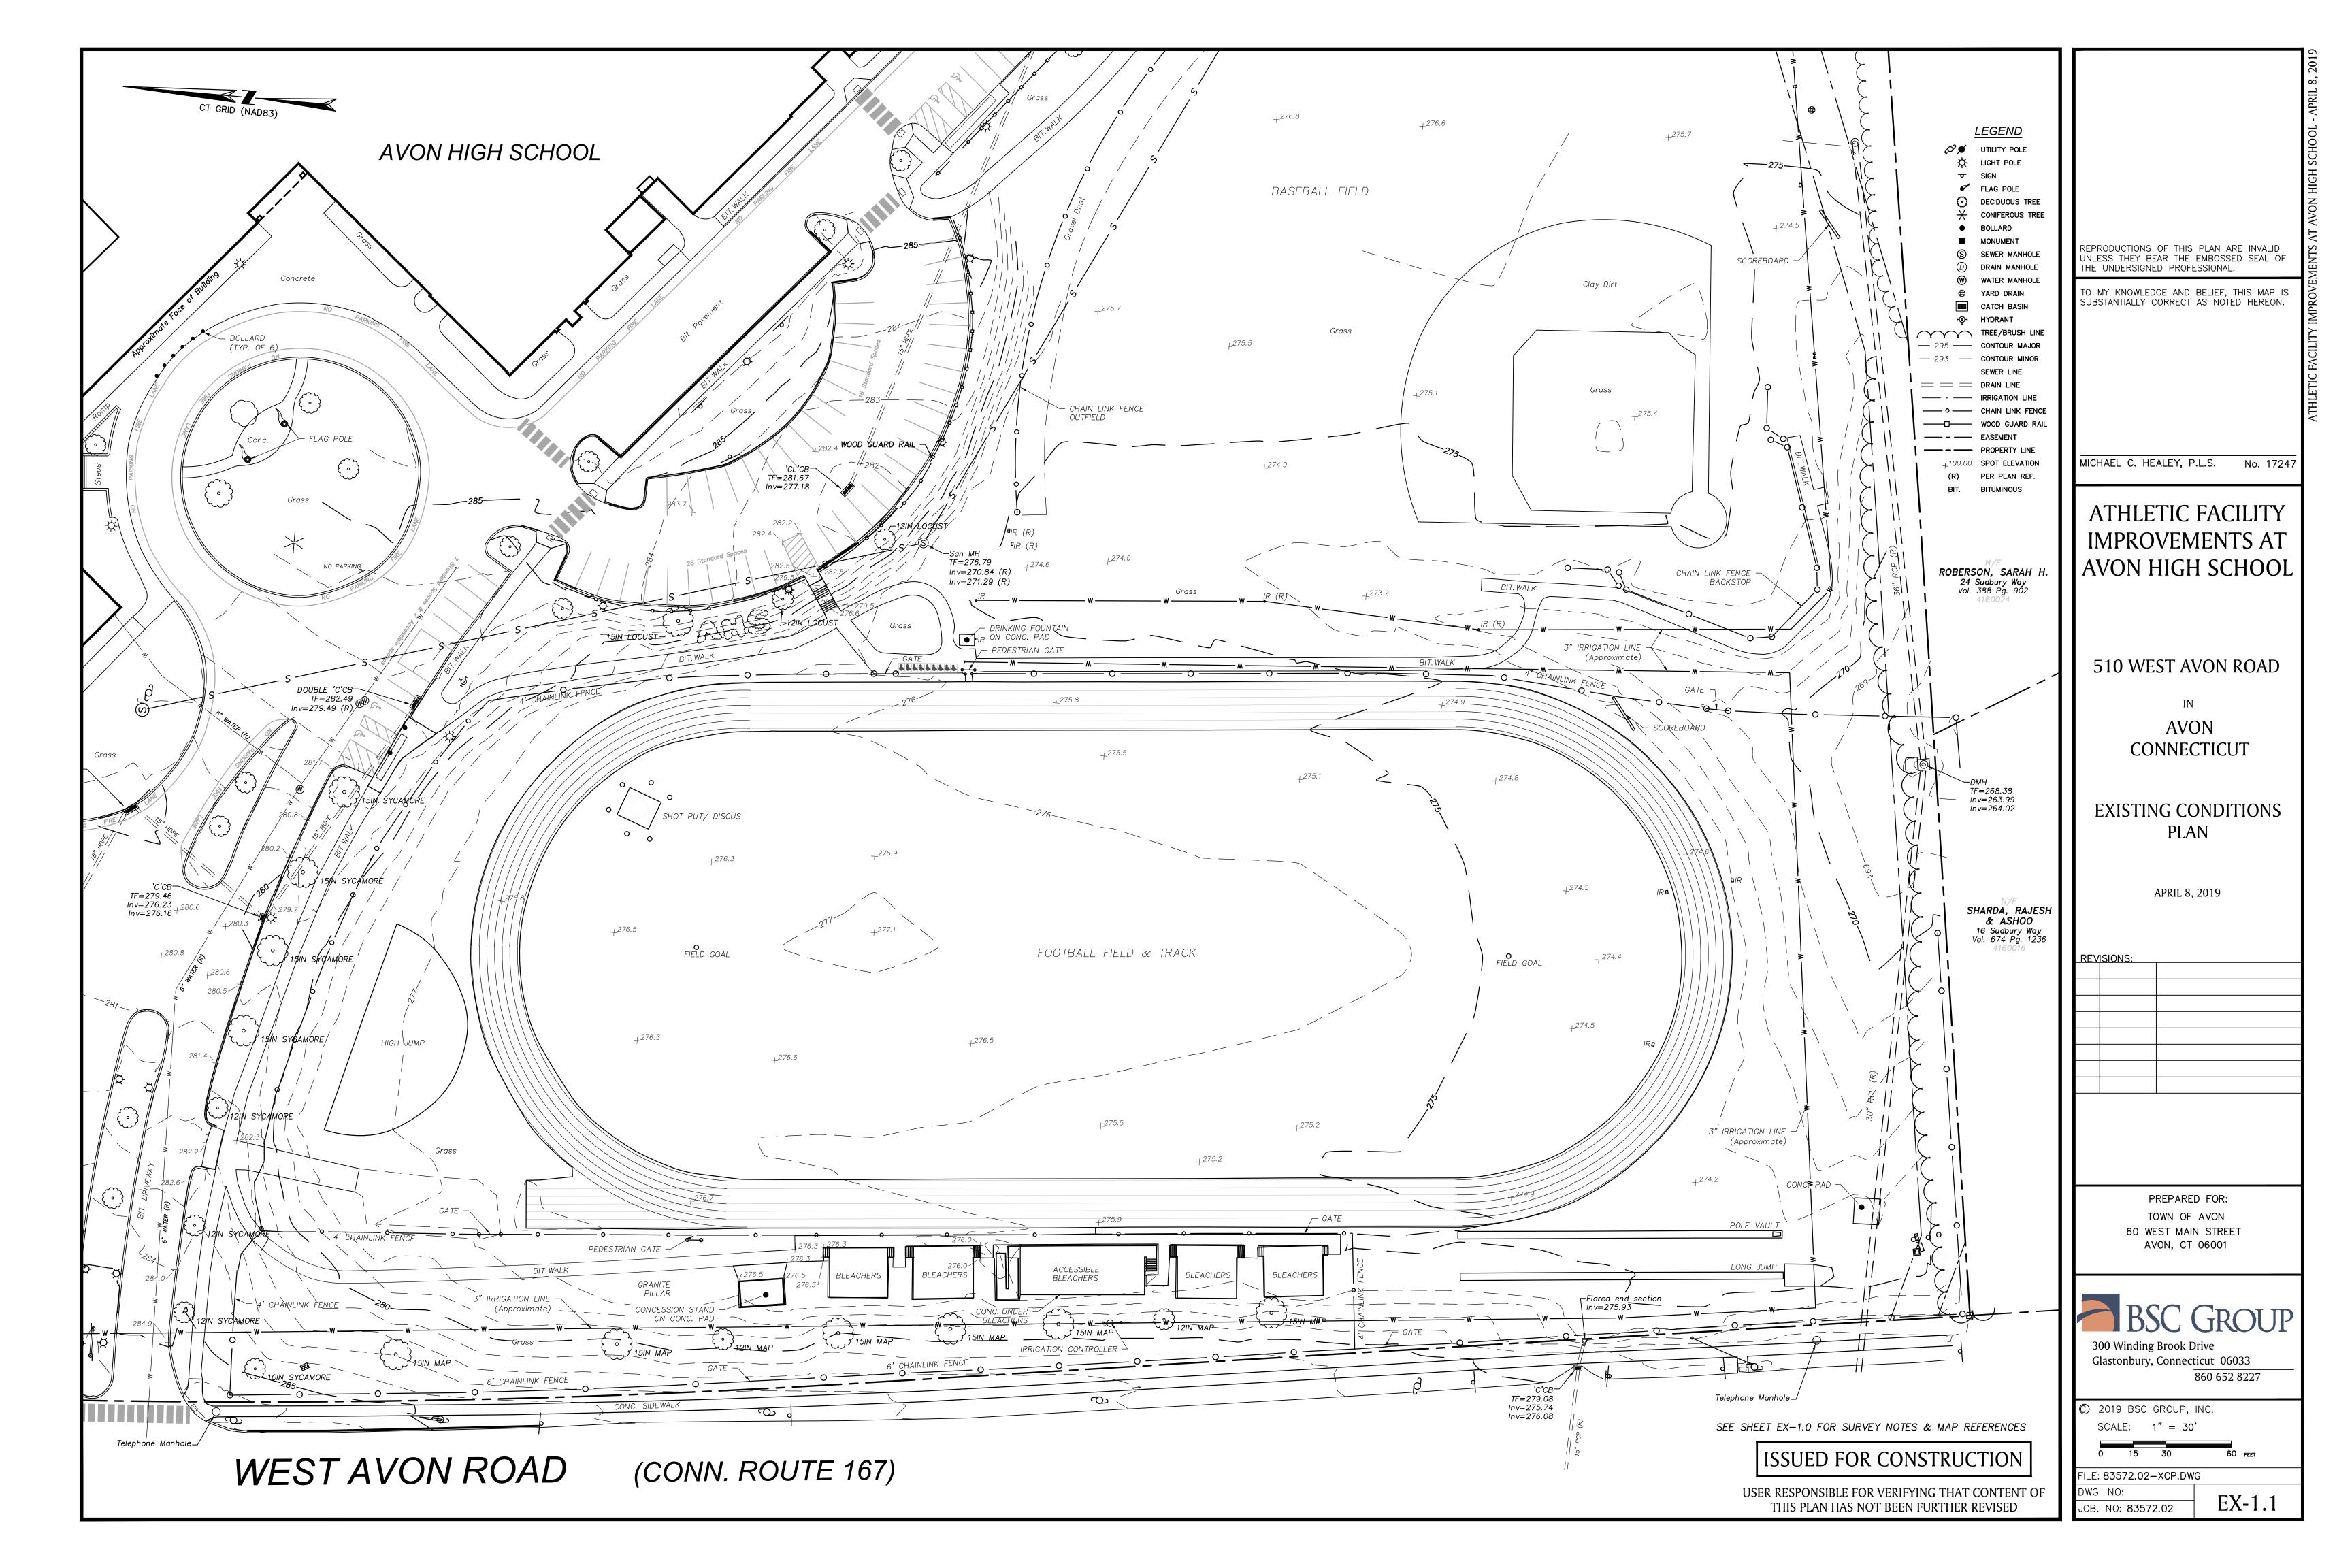



_		
E&S MEASURE	MAINTENANCE MEASURES	SCHEDULE
FILTER INSERTS IN DRAINAGE SYSTEM	CLEAN CATCH BASIN GRATE, REMOVE SEDIMENT/DEBRIS FROM FILTER INSERTS.	WEEKLY & WITHIN 24 HOURS AFTER STORM GENERATING A DISCHARGE
HAY BALES/ SILT FENCE BARRIER	REPAIR/REPLACE WHEN FAILURE OBSERVED. REMOVE SILT WHEN ACCUMULATION REACHES APPROX. HALF HEIGHT OF FENCE.	WEEKLY & WITHIN 24 HOURS AFTER STORM GENERATING A DISCHARGE
TEMPORARY STOCKPILES	ENSURE PERIMETER SILT FENCE IS IN-PLACE. REPAIR/REPLACE WHEN FAILURE OBSERVED. REMOVE SILT WHEN ACCUMULATION REACHES APPROX. HALF HEIGHT OF FENCE.	DAILY
CONSTRUCTION ENTRANCE	SWEEP PAVED ROADWAY ADJACENT TO SITE ENTRANCE AS NECESSARY, REFRESH STONE AS NECESSARY, REMOVE SILTED GRAVEL.	WEEKLY
MOISTEN EXPOSED SOILS	PERIODICALLY MOISTEN EXPOSED SOIL SURFACES WITH WATER ON UNPAVED TRAVELWAYS AND KEEP TRAVELWAYS DAMP.	DAILY

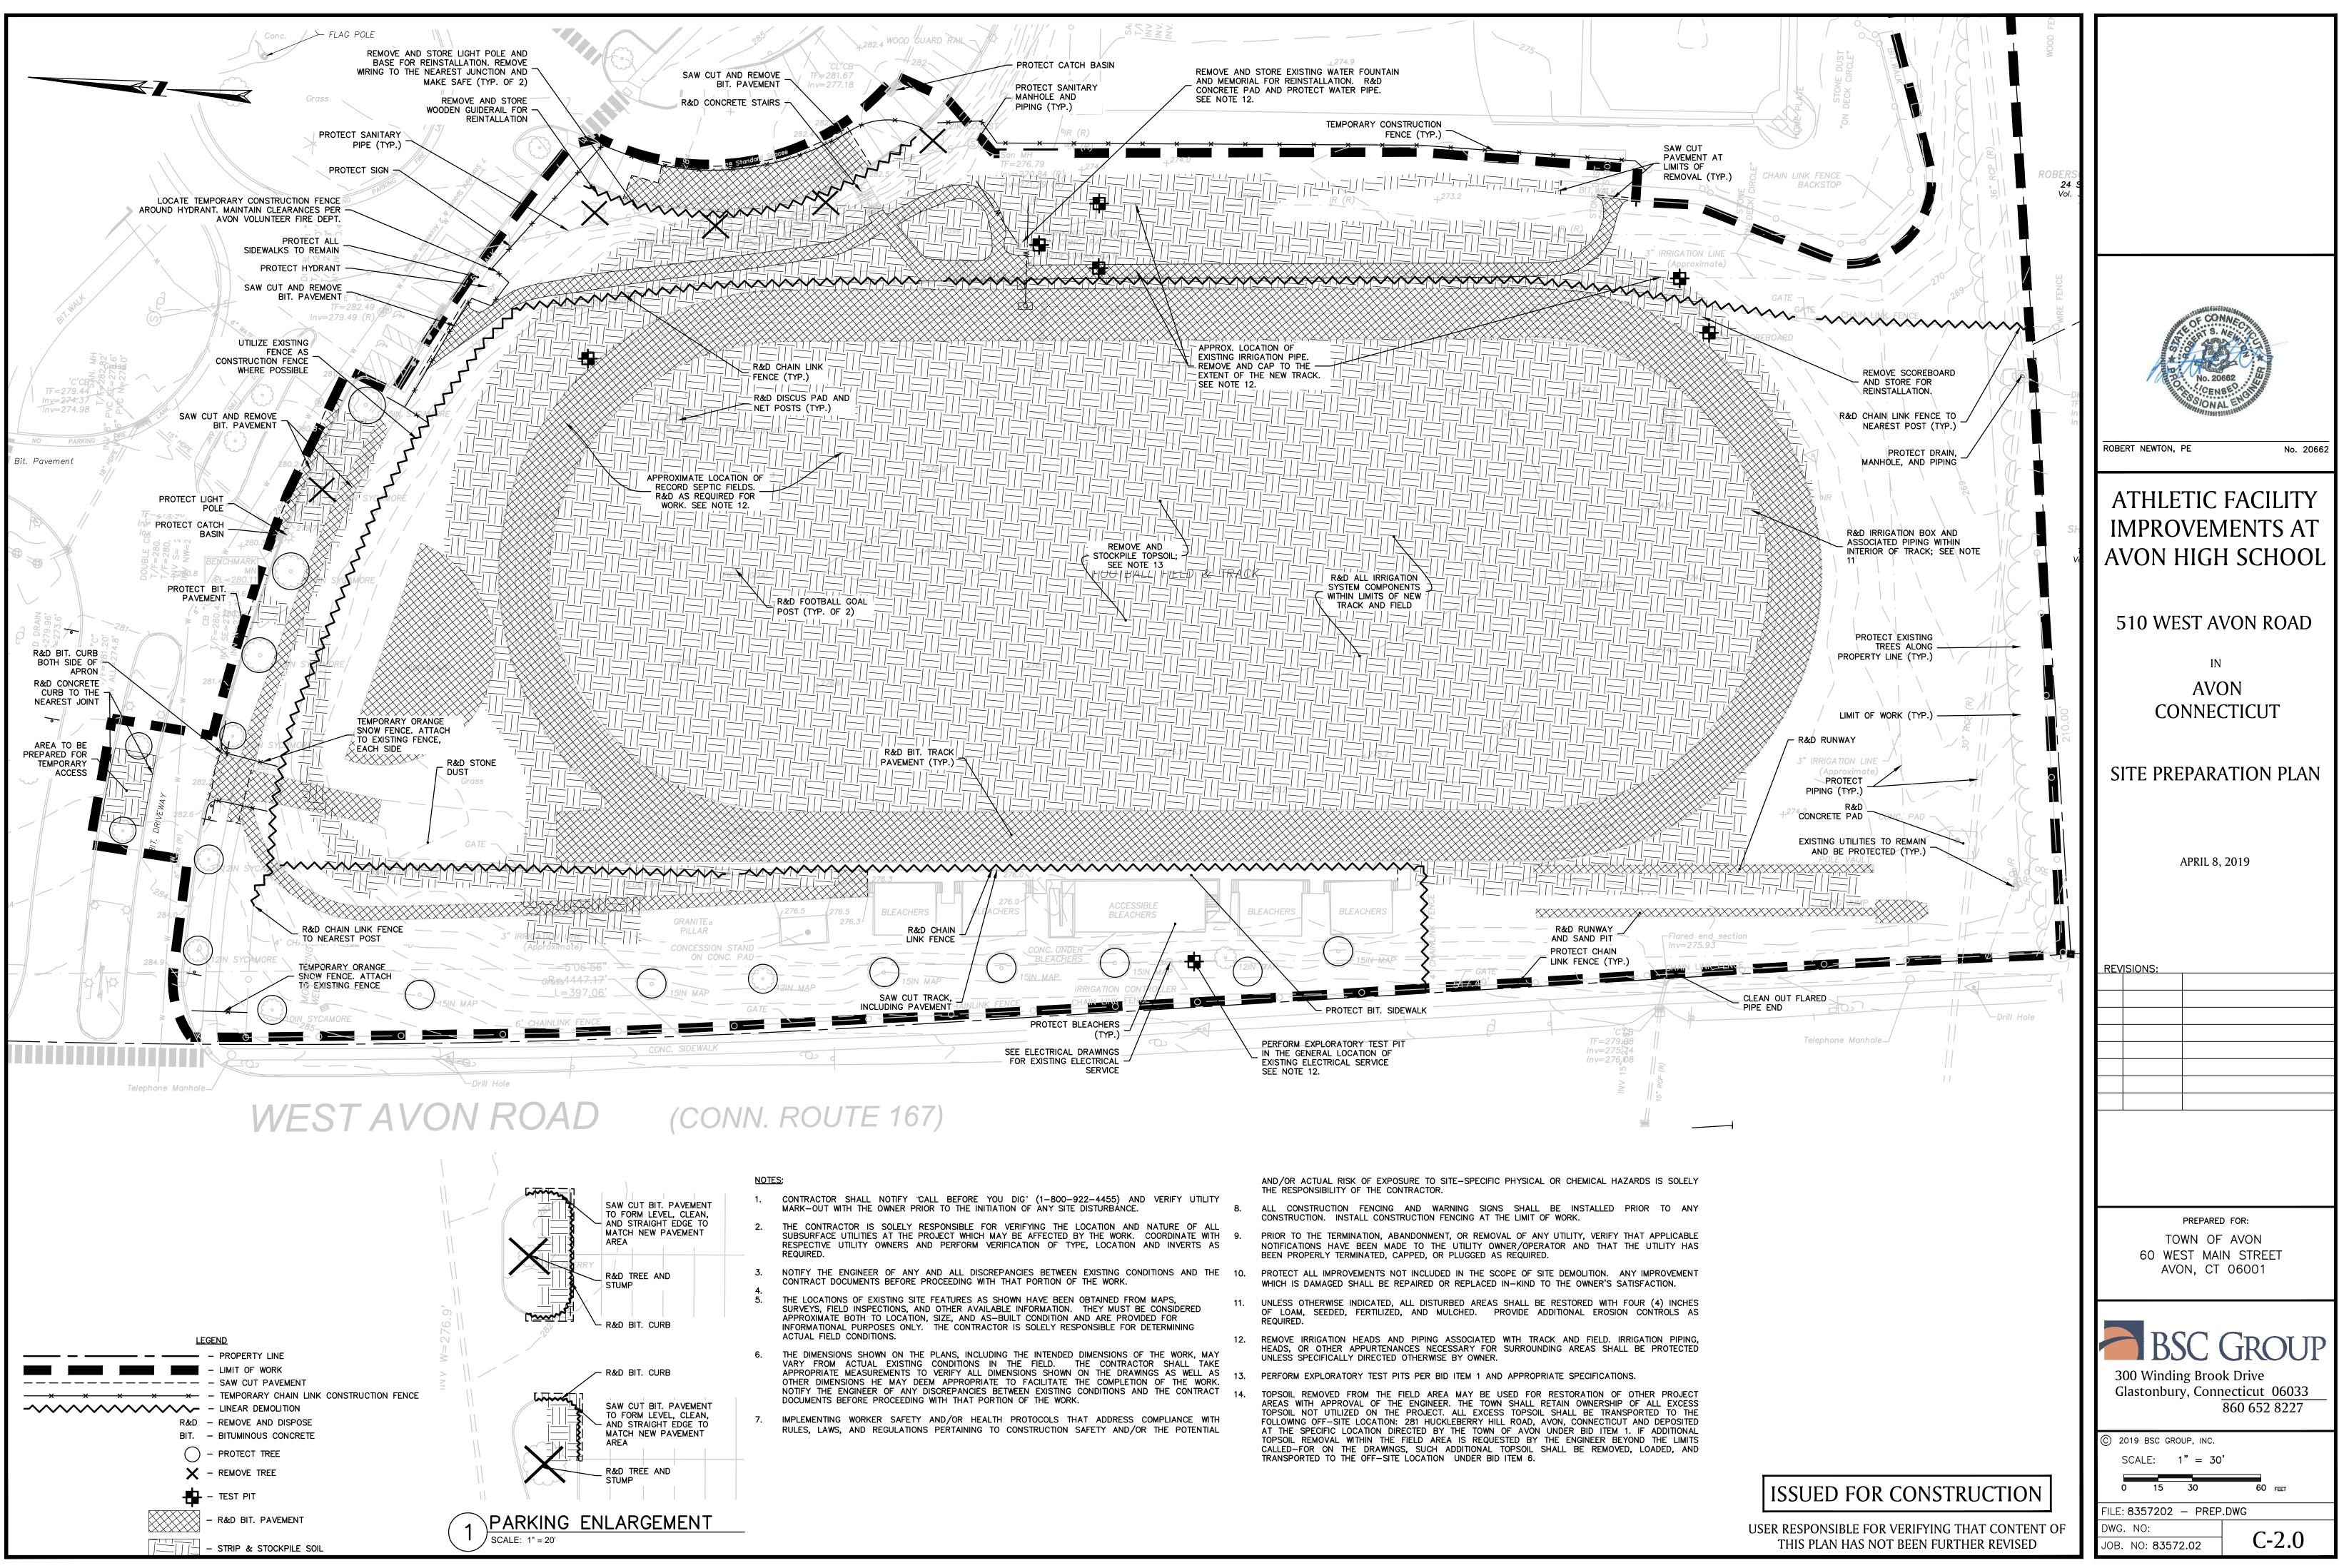


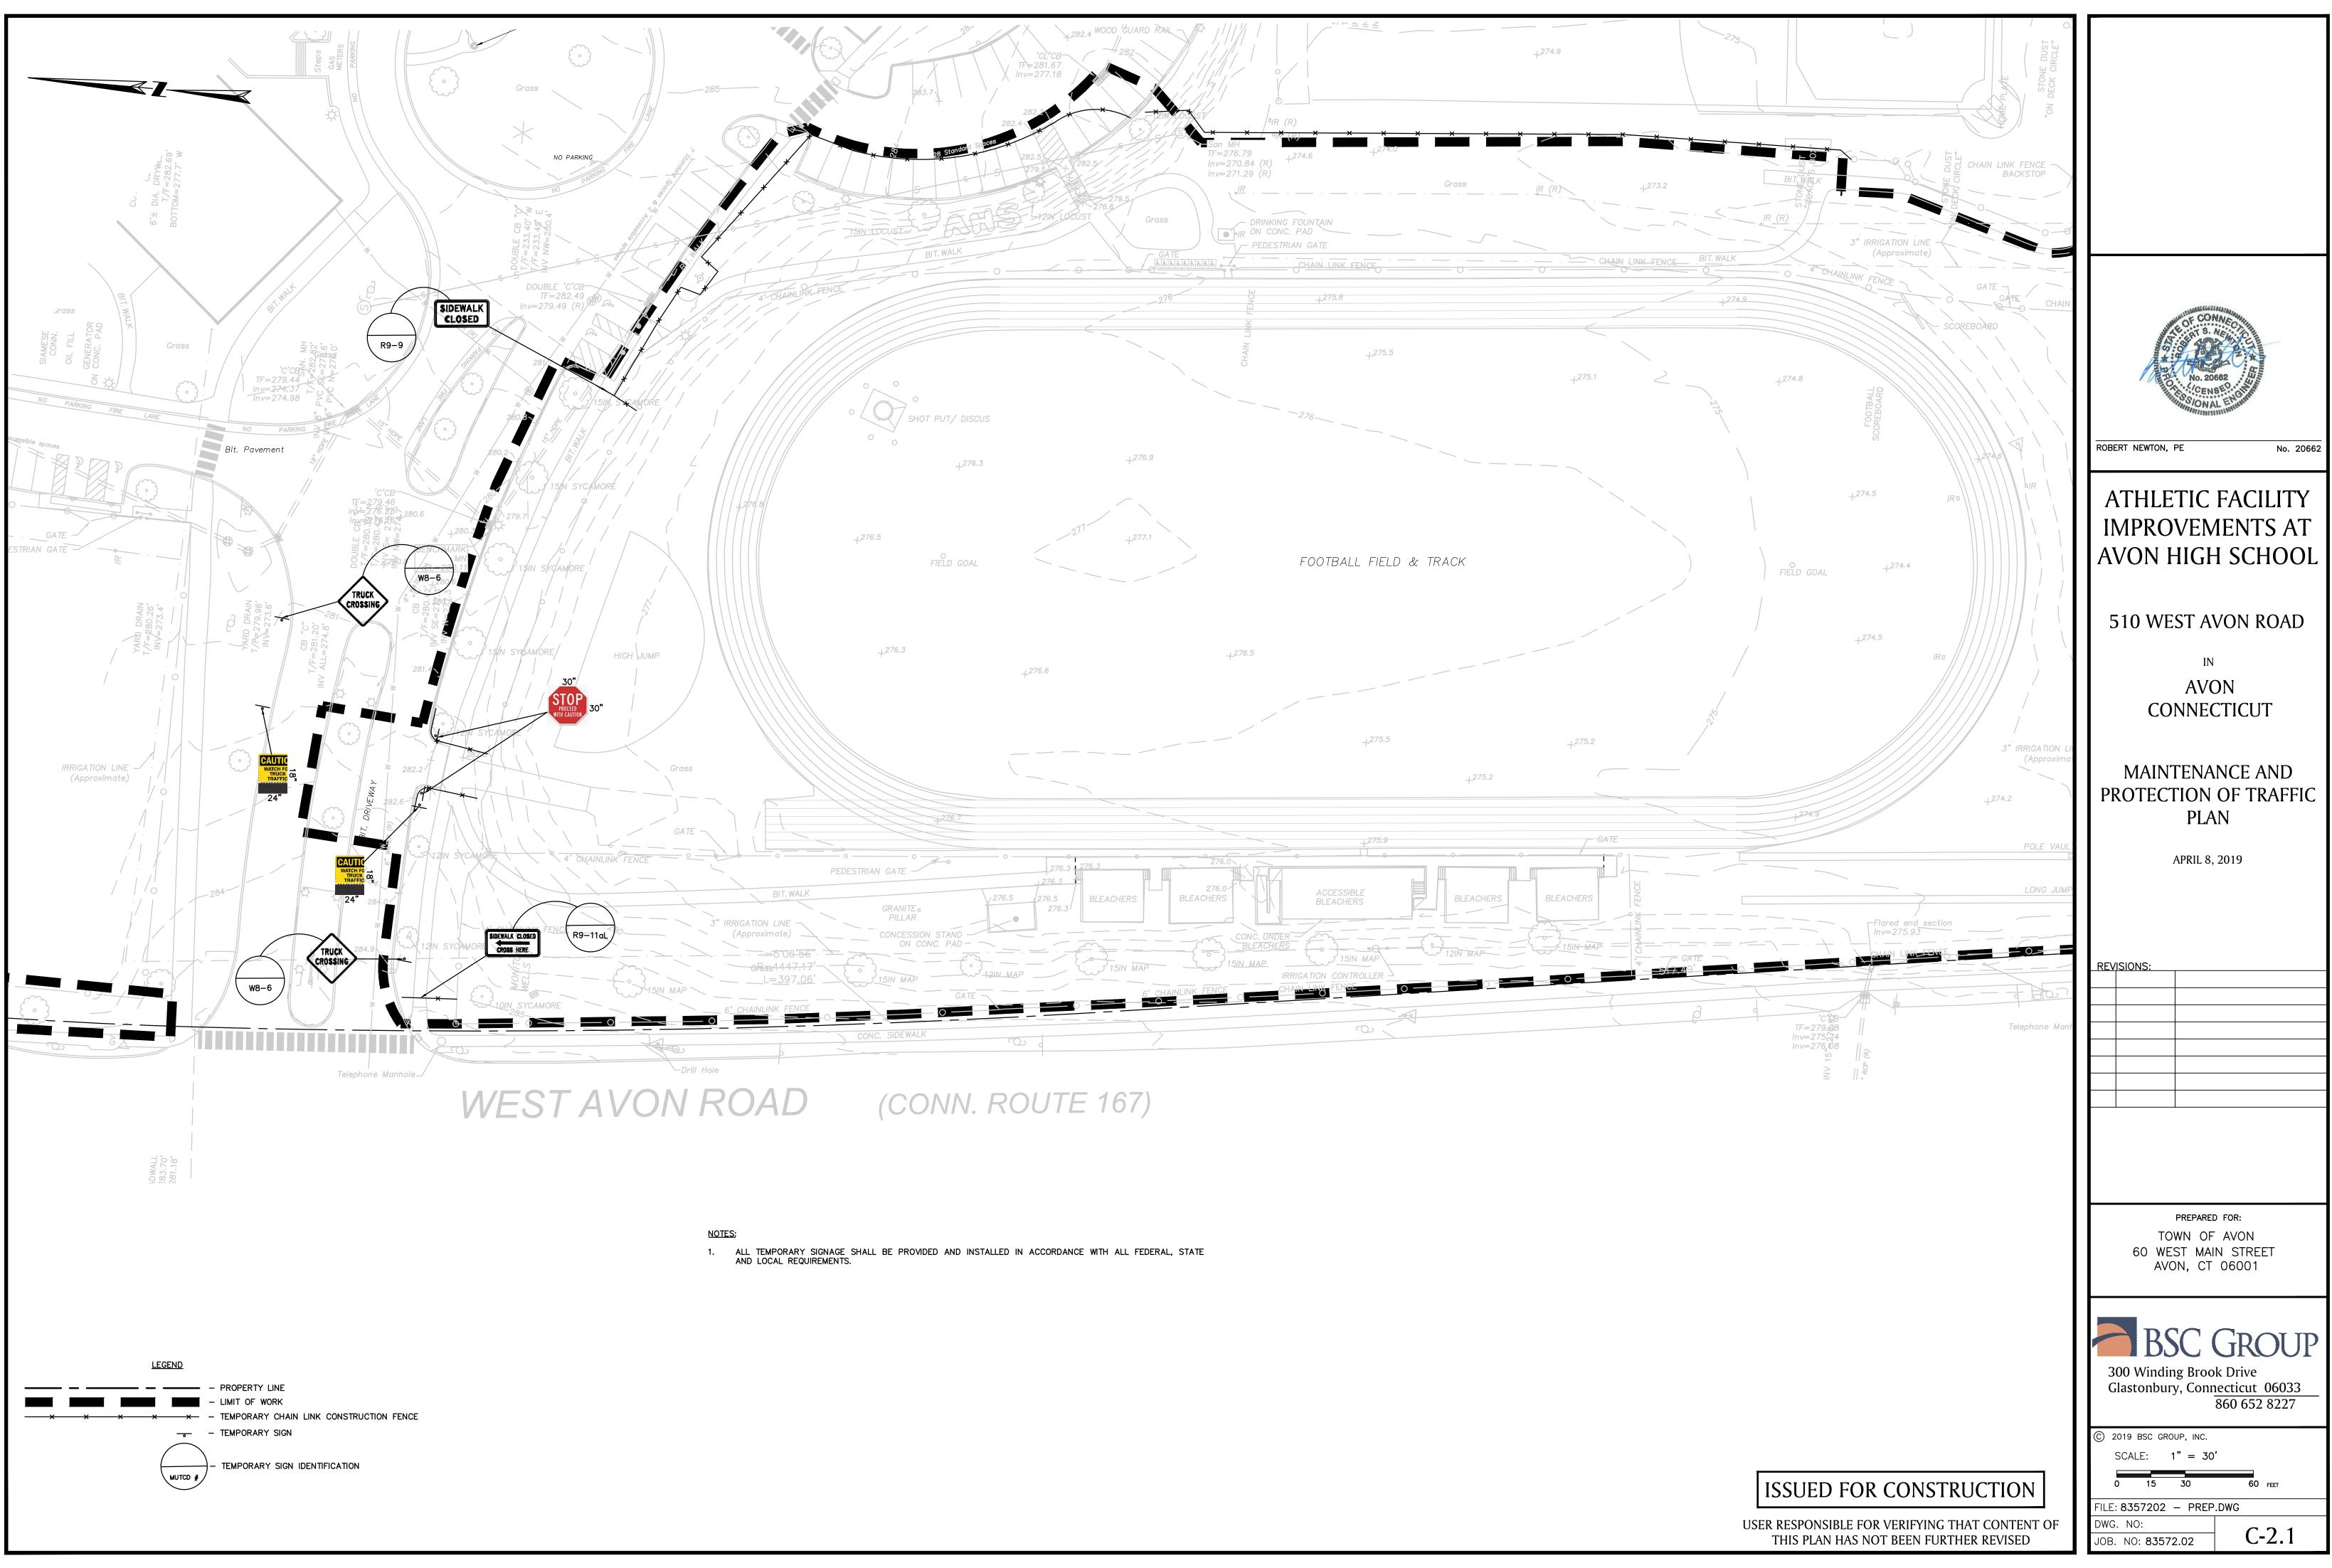

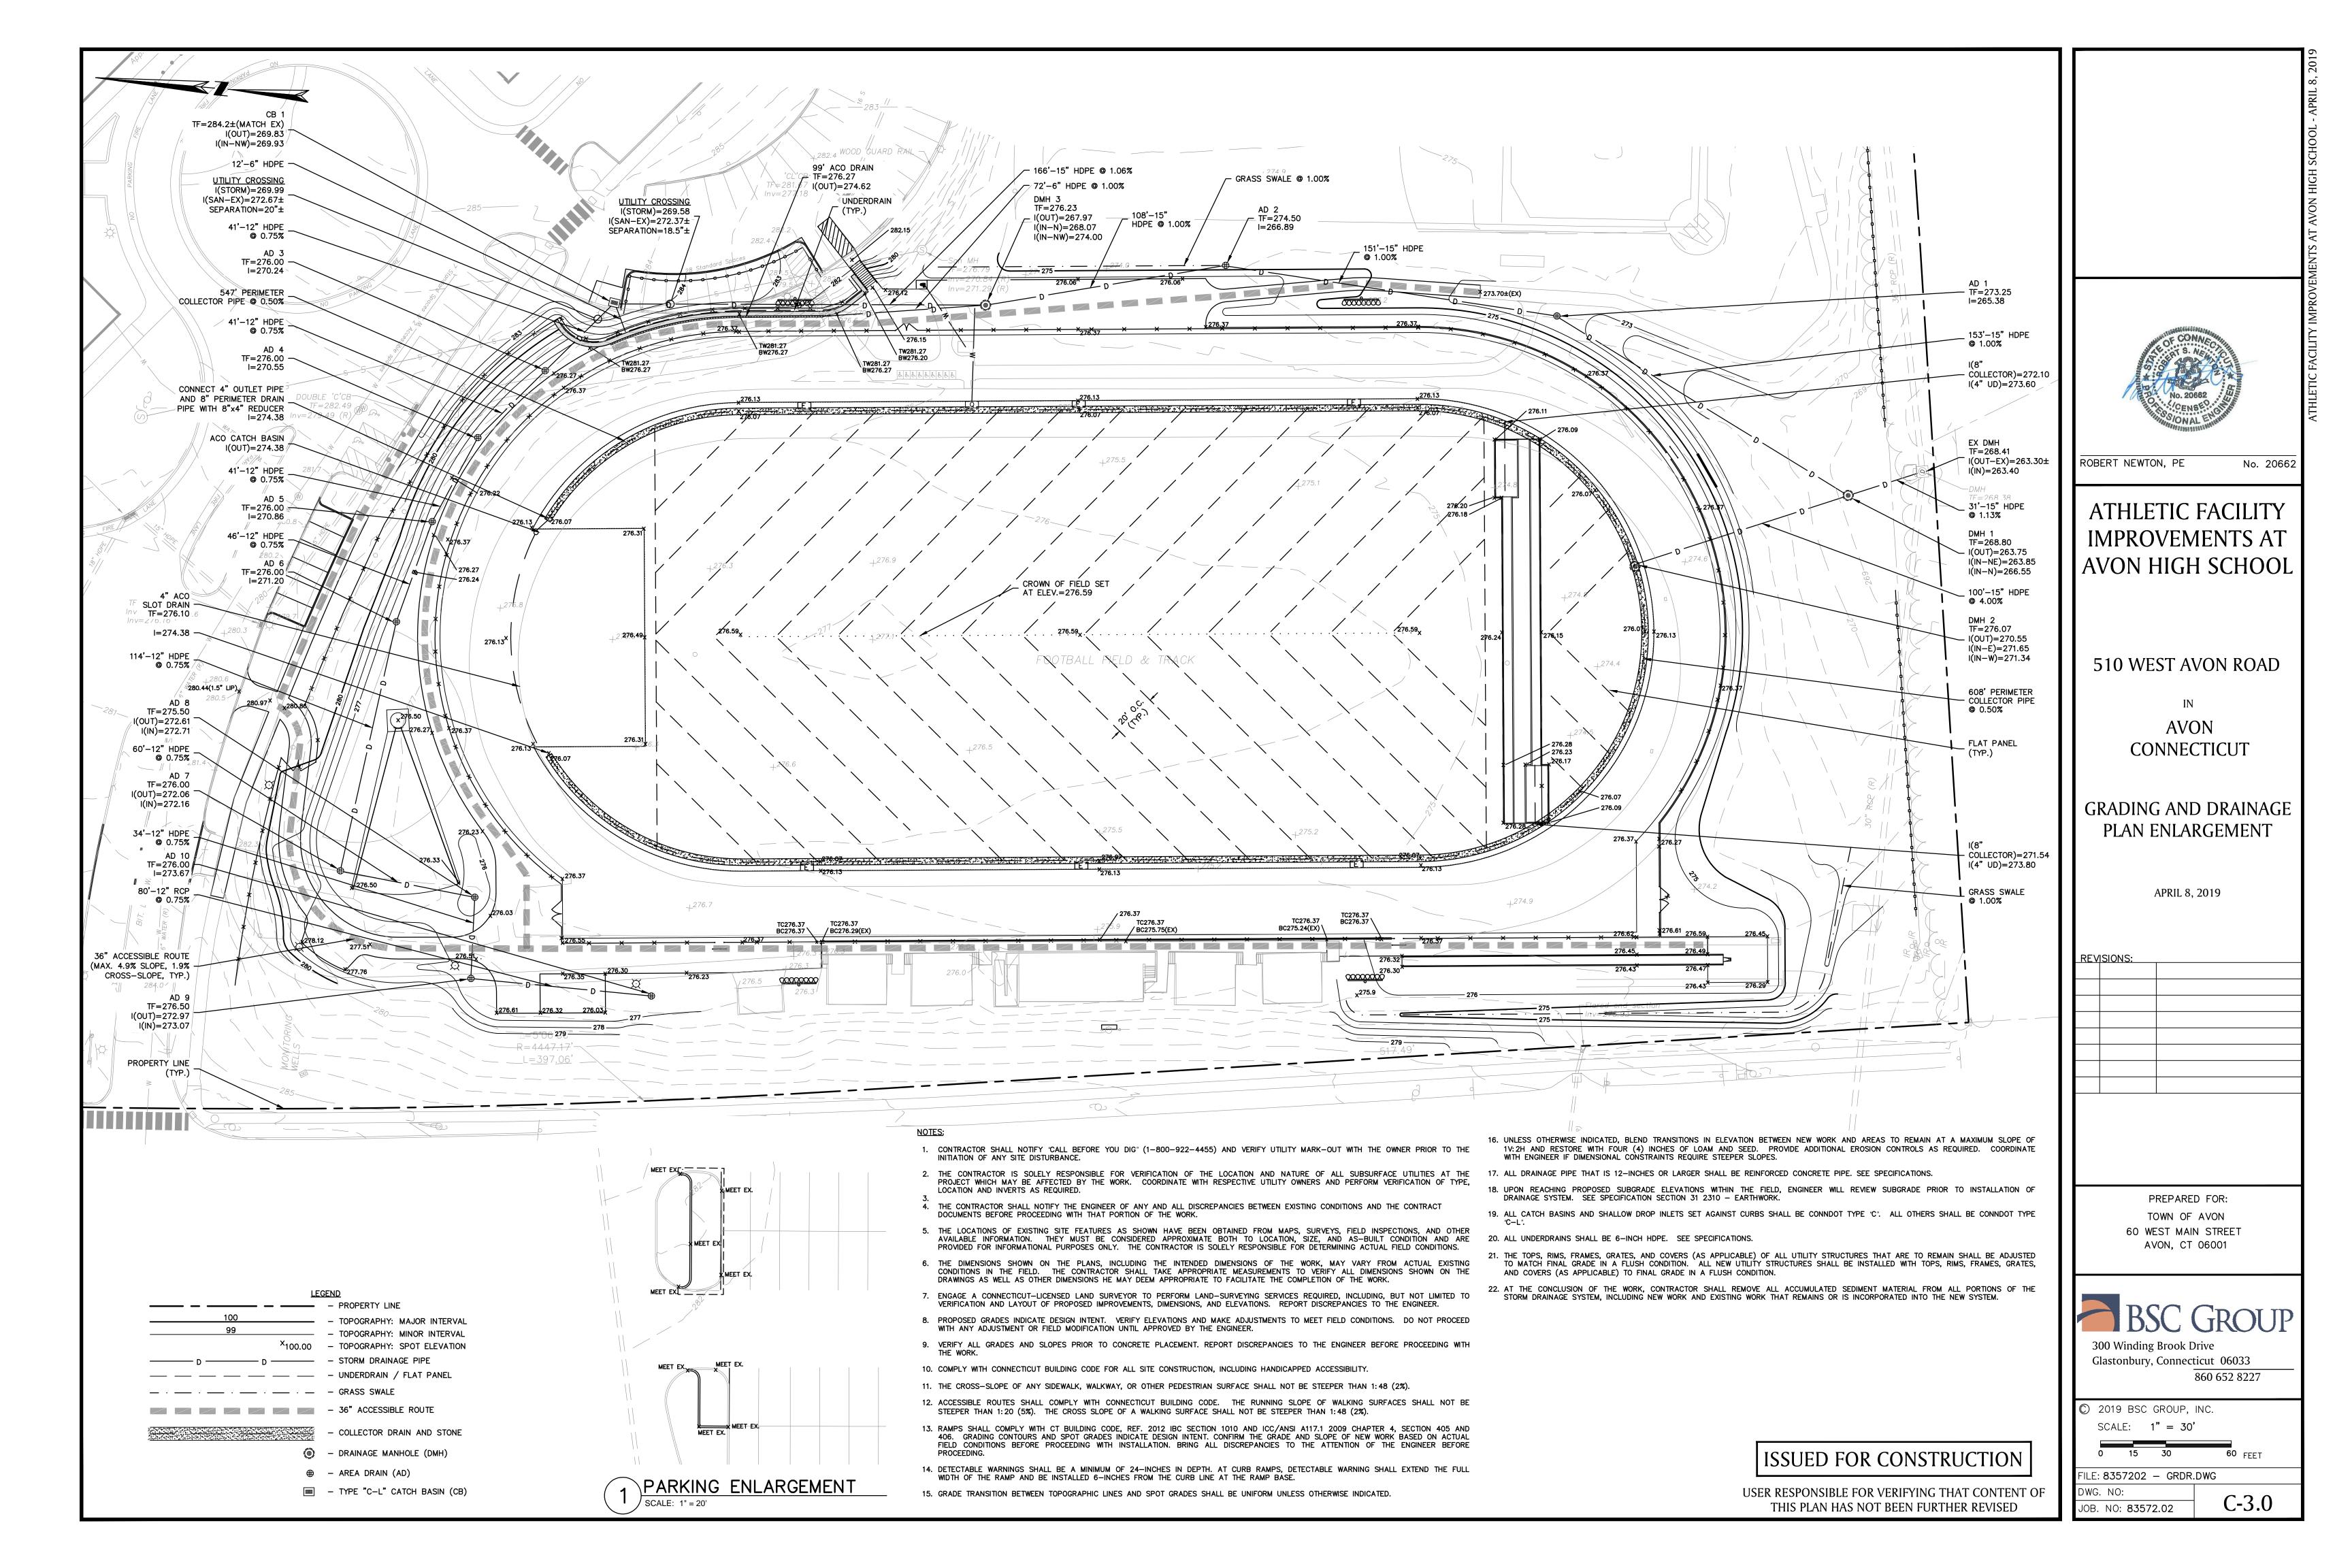

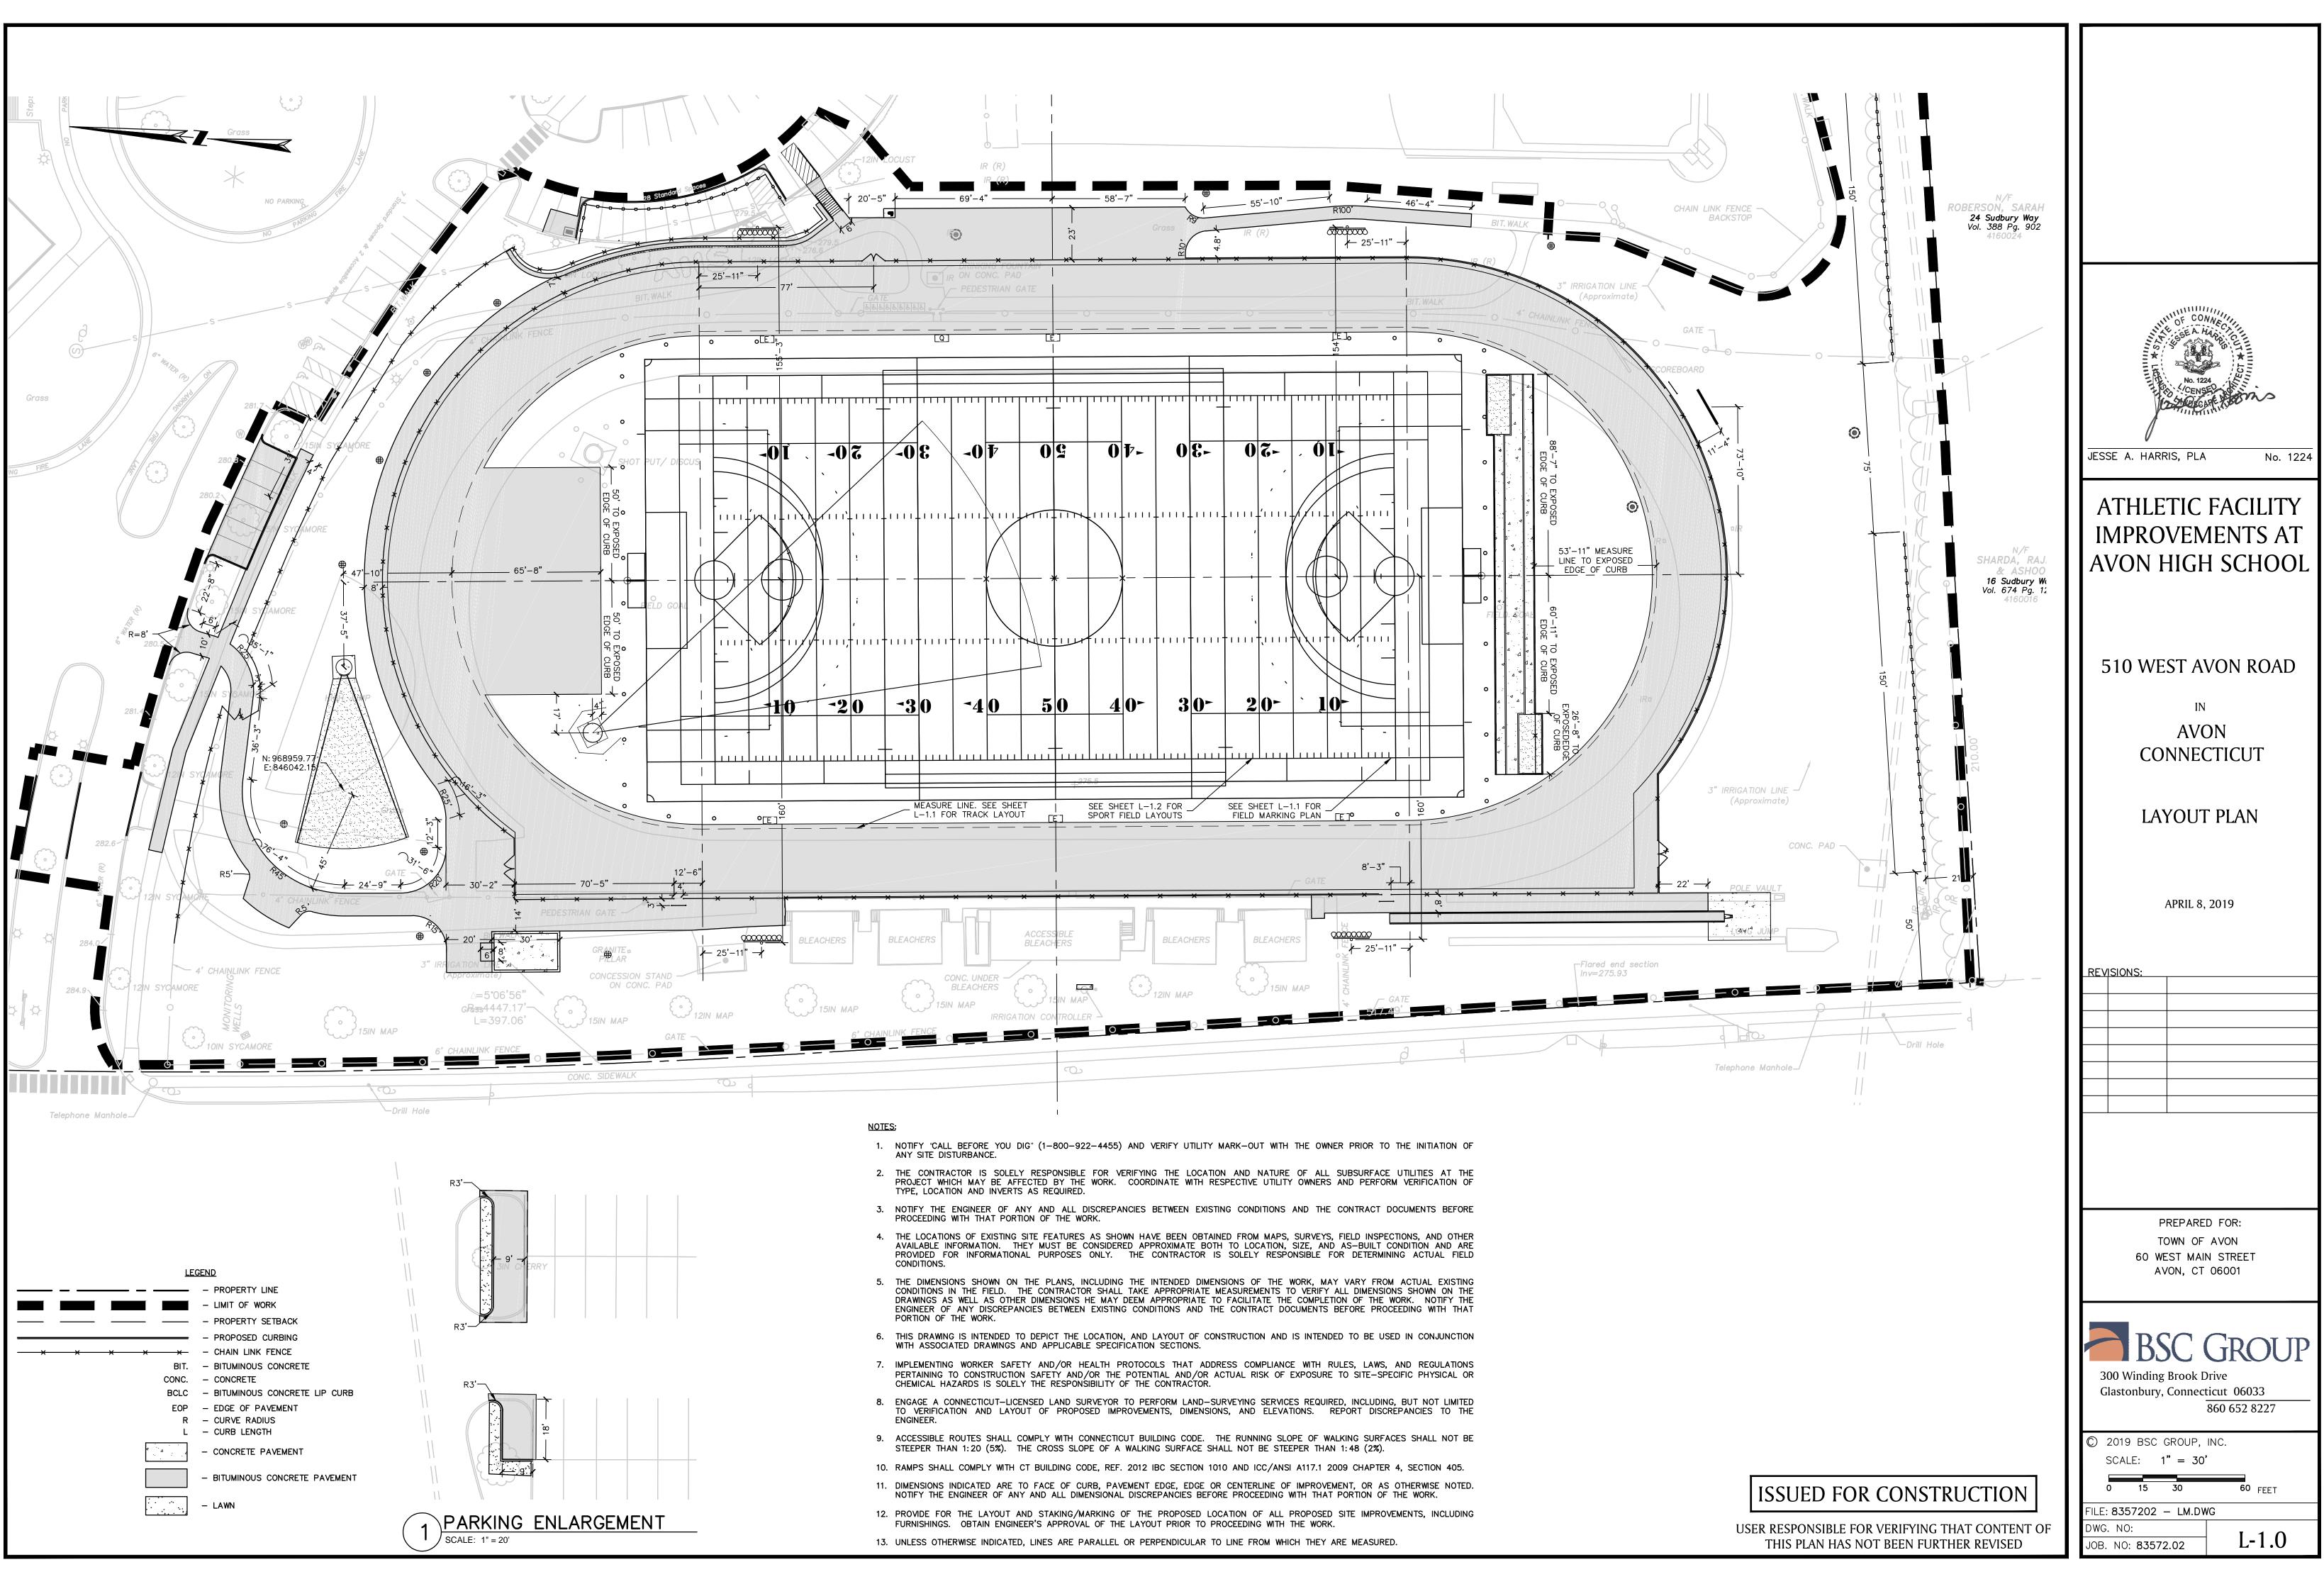


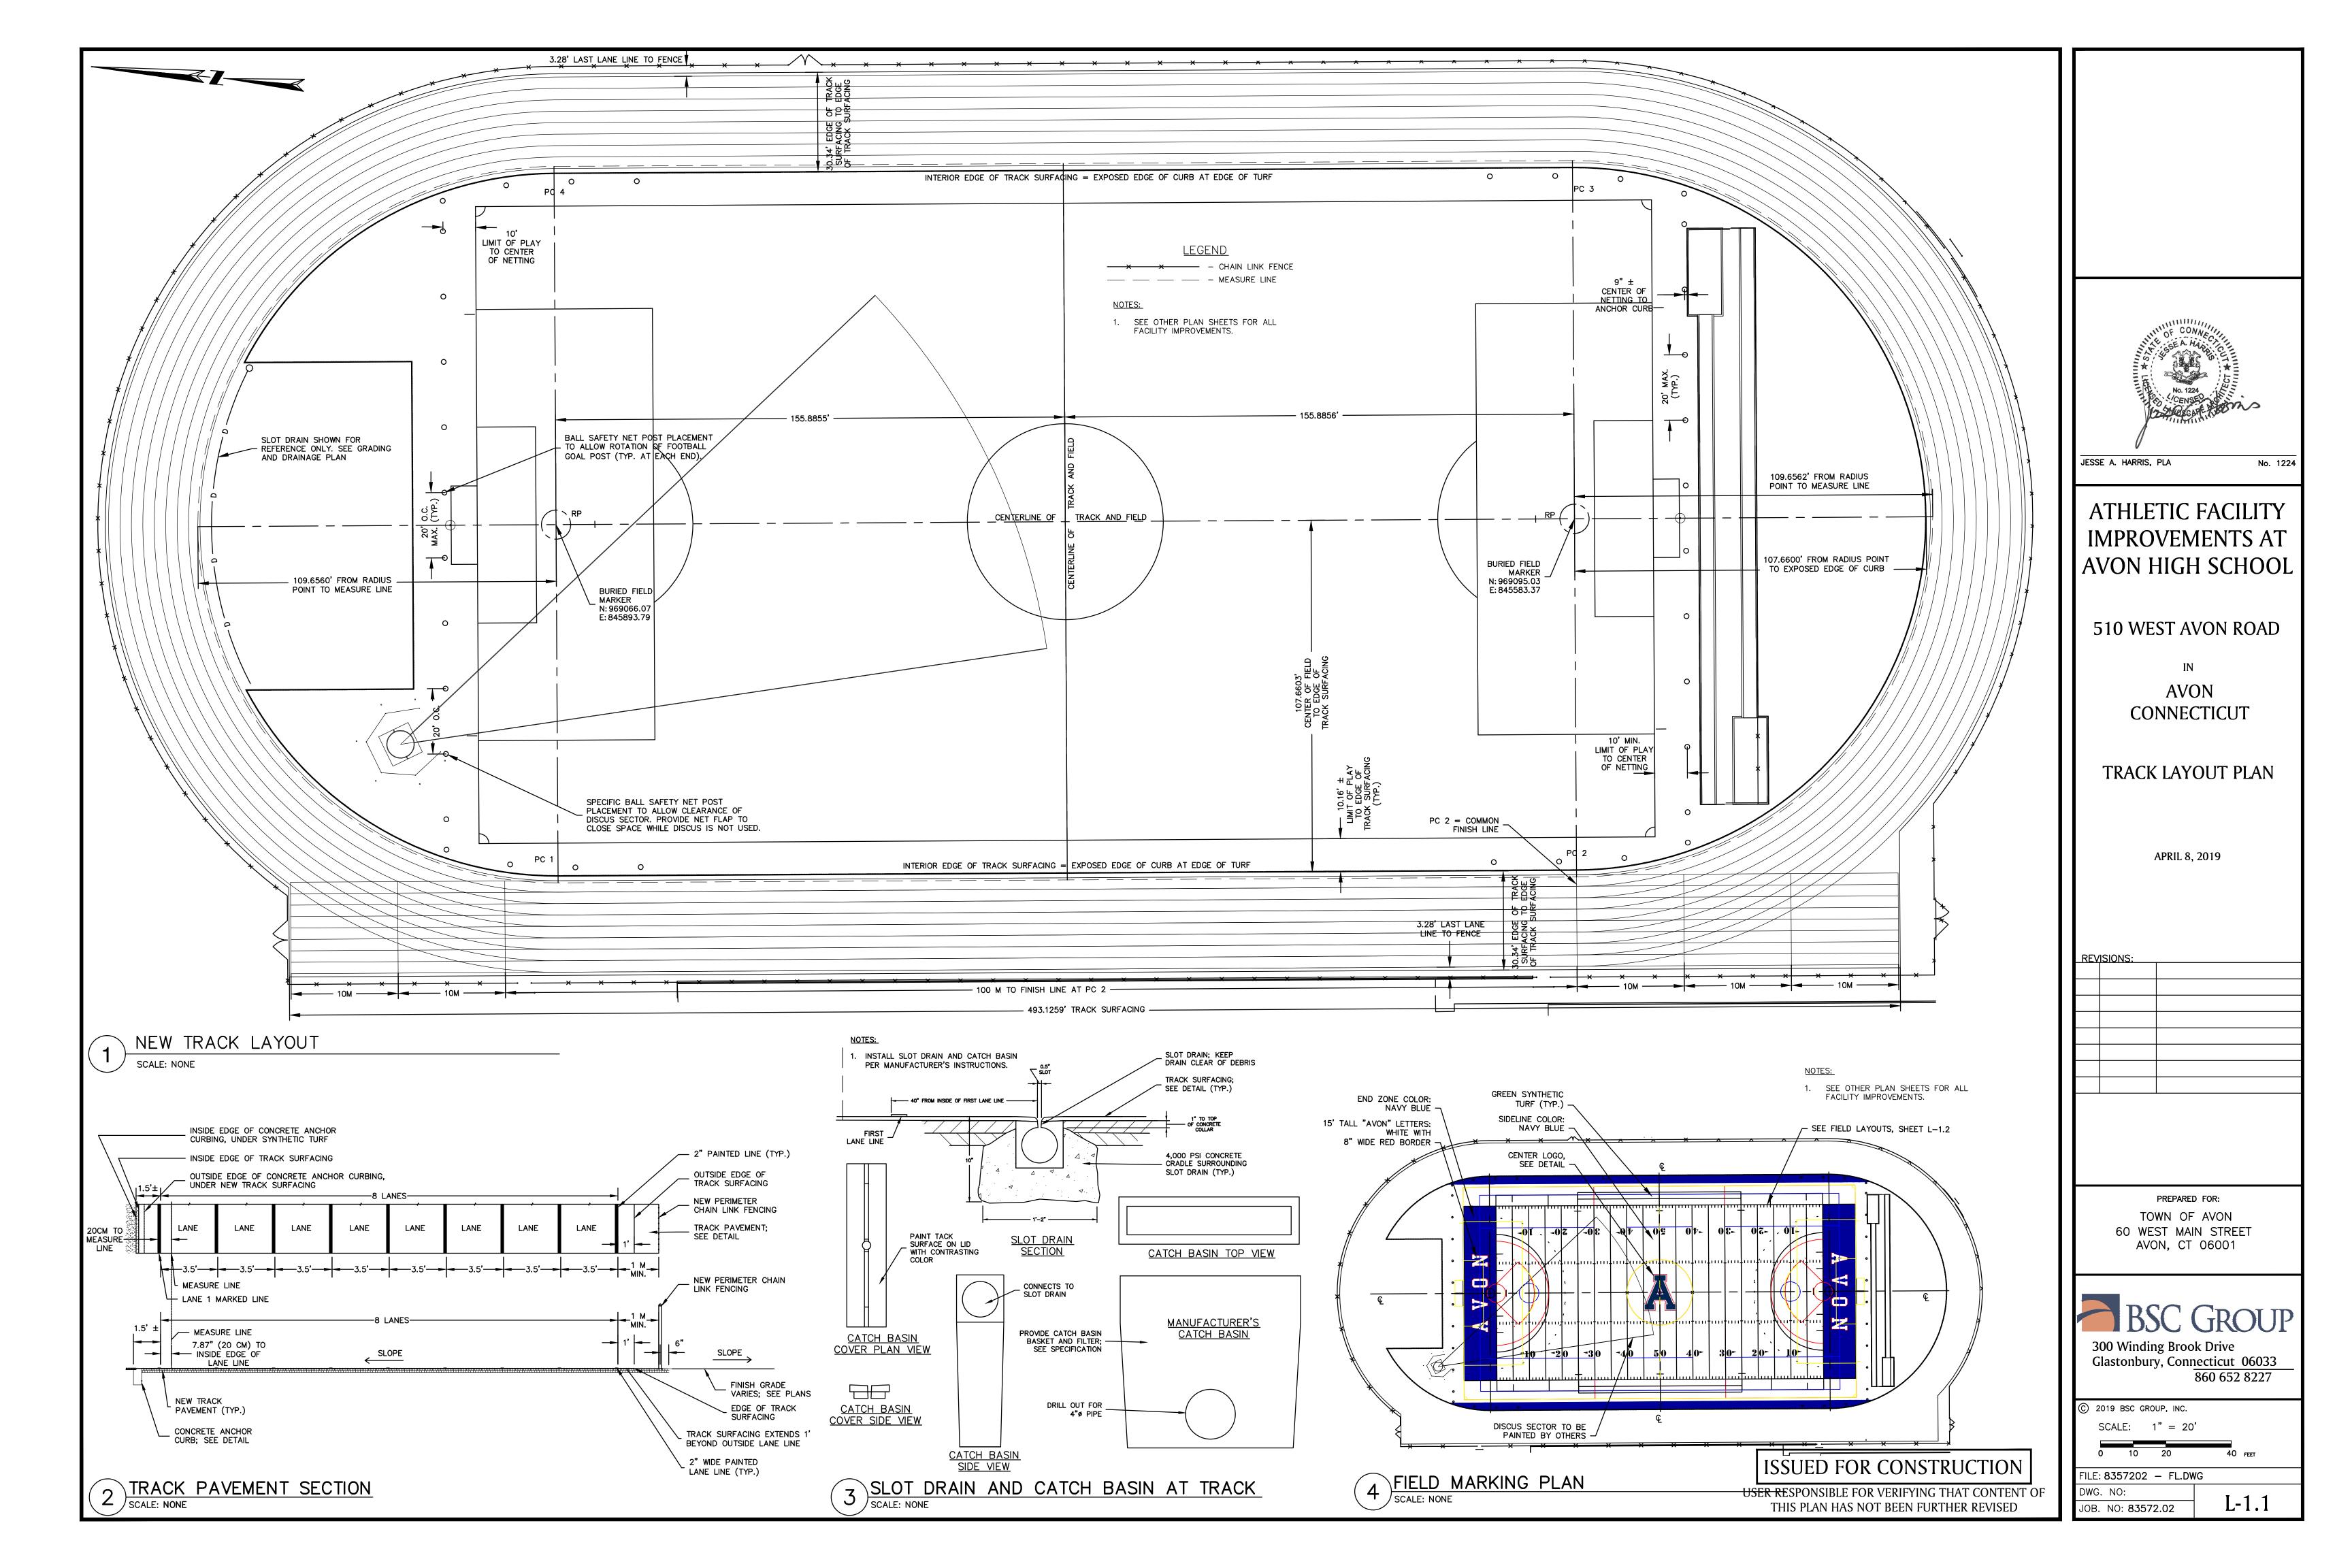

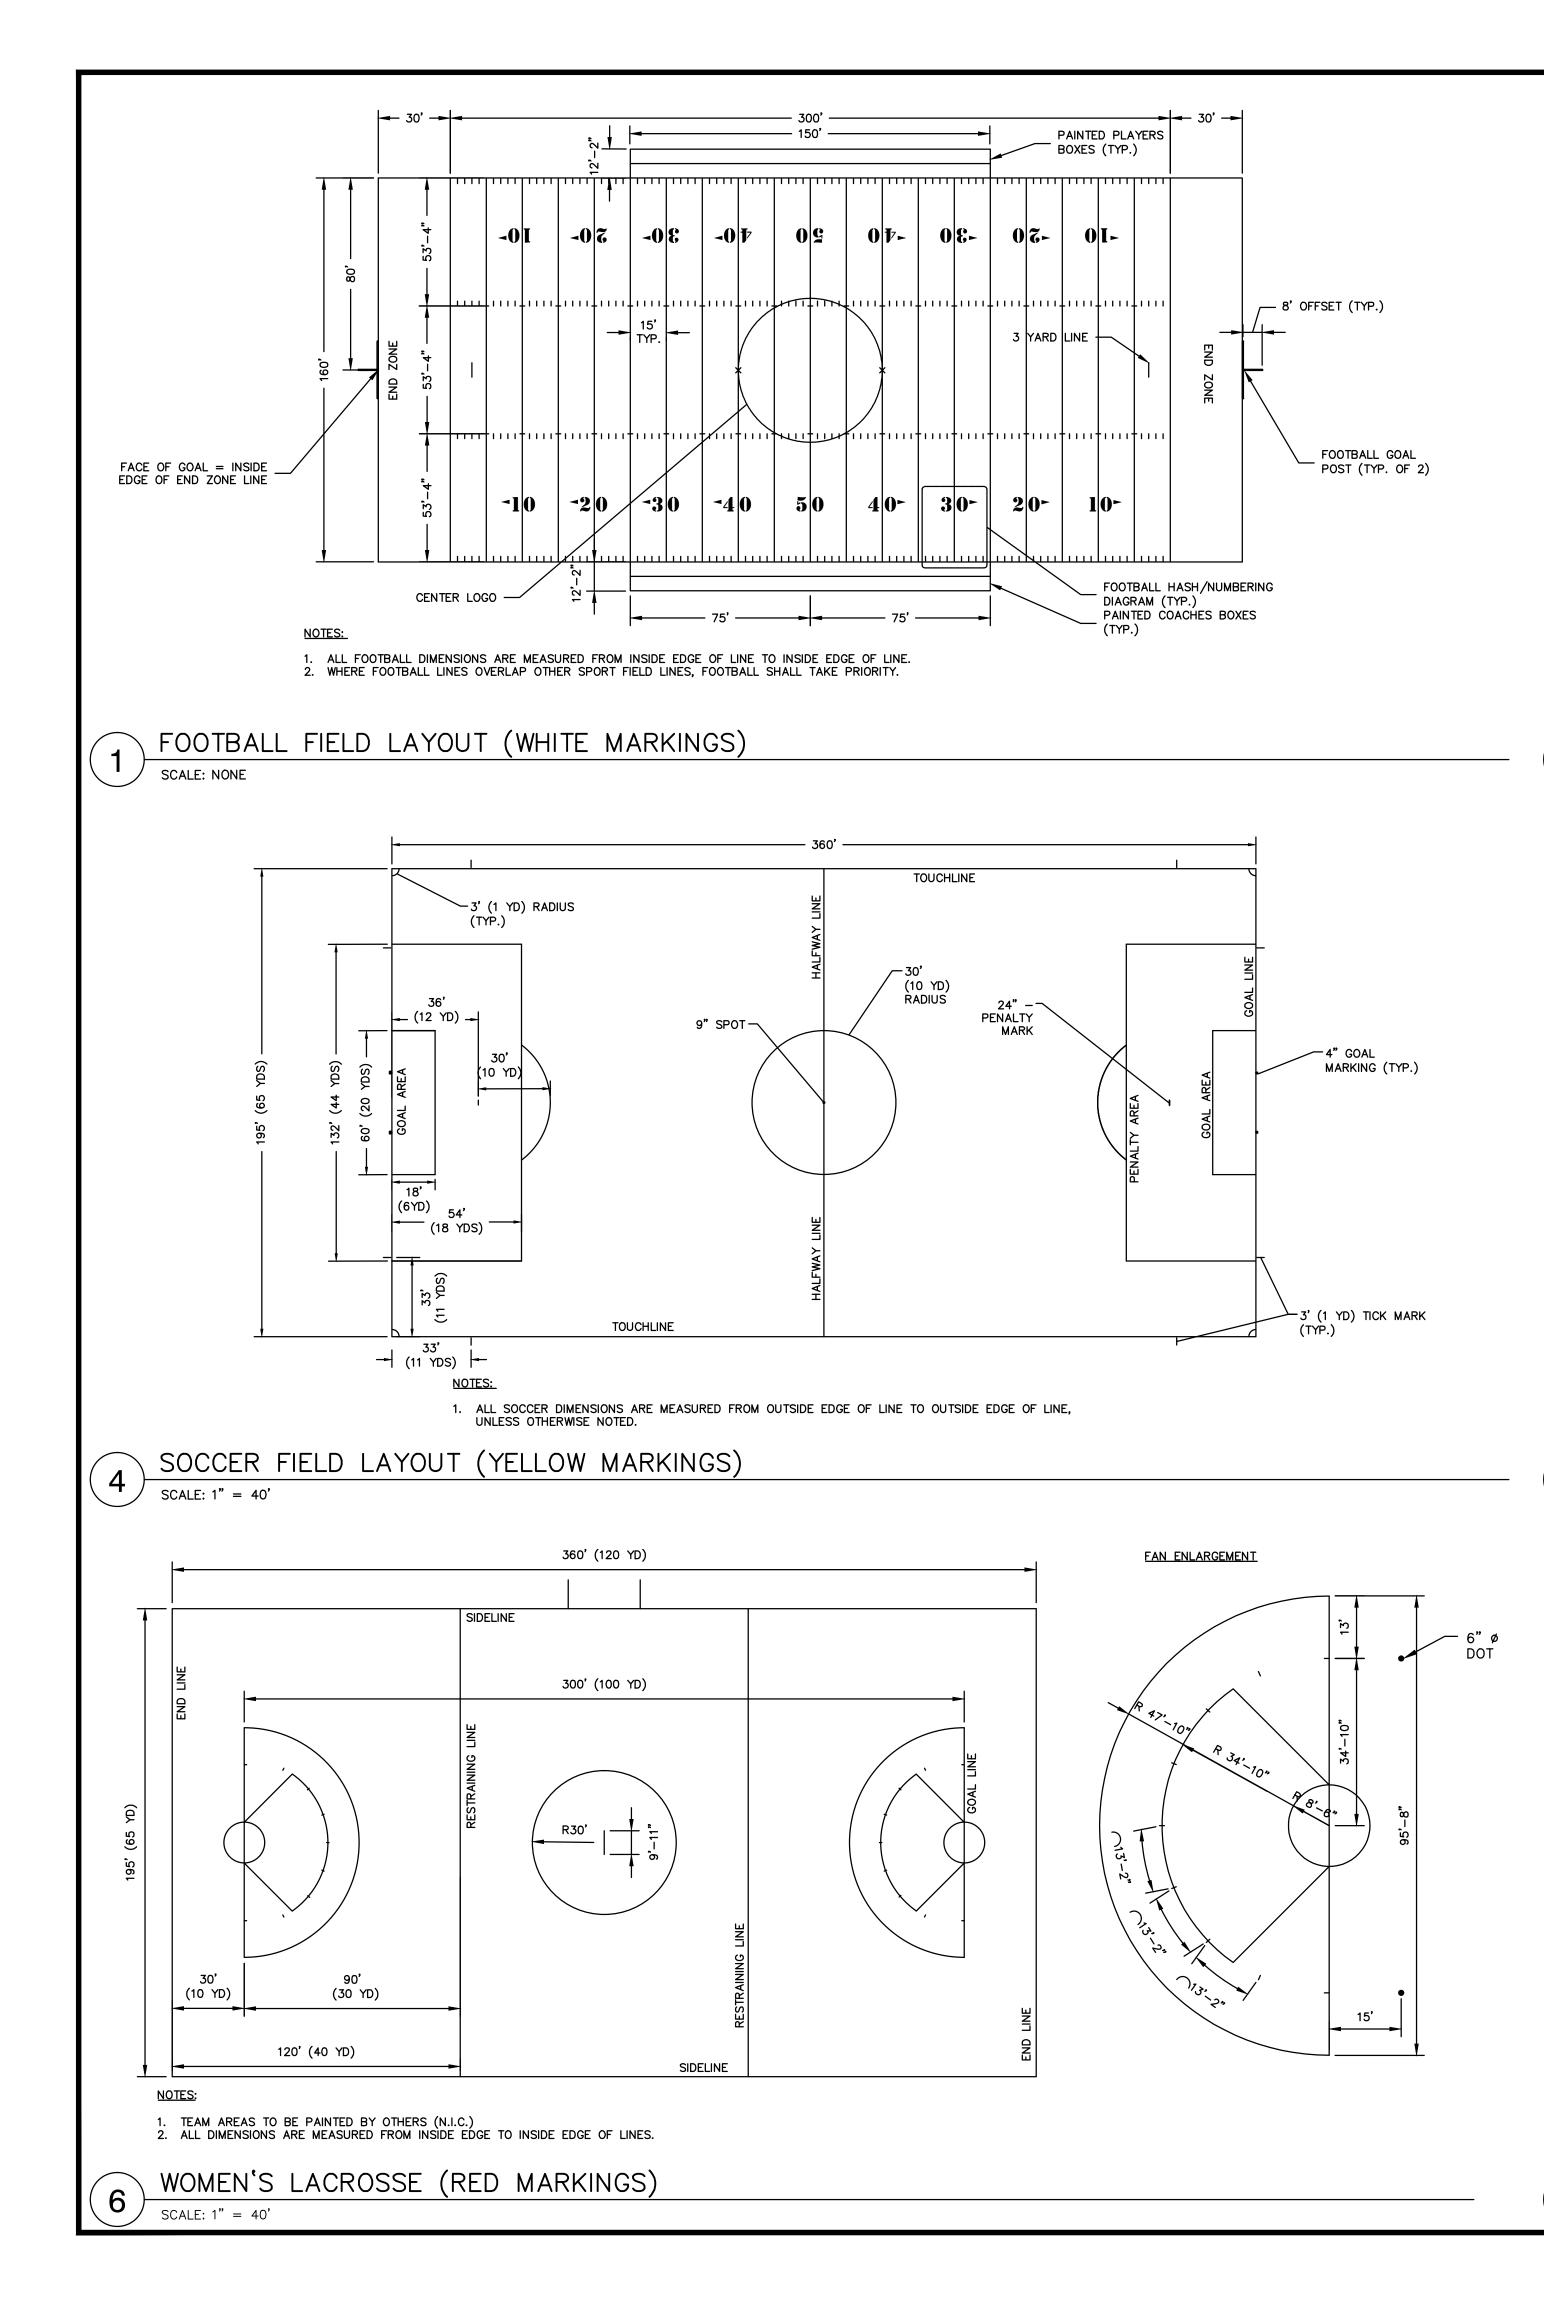



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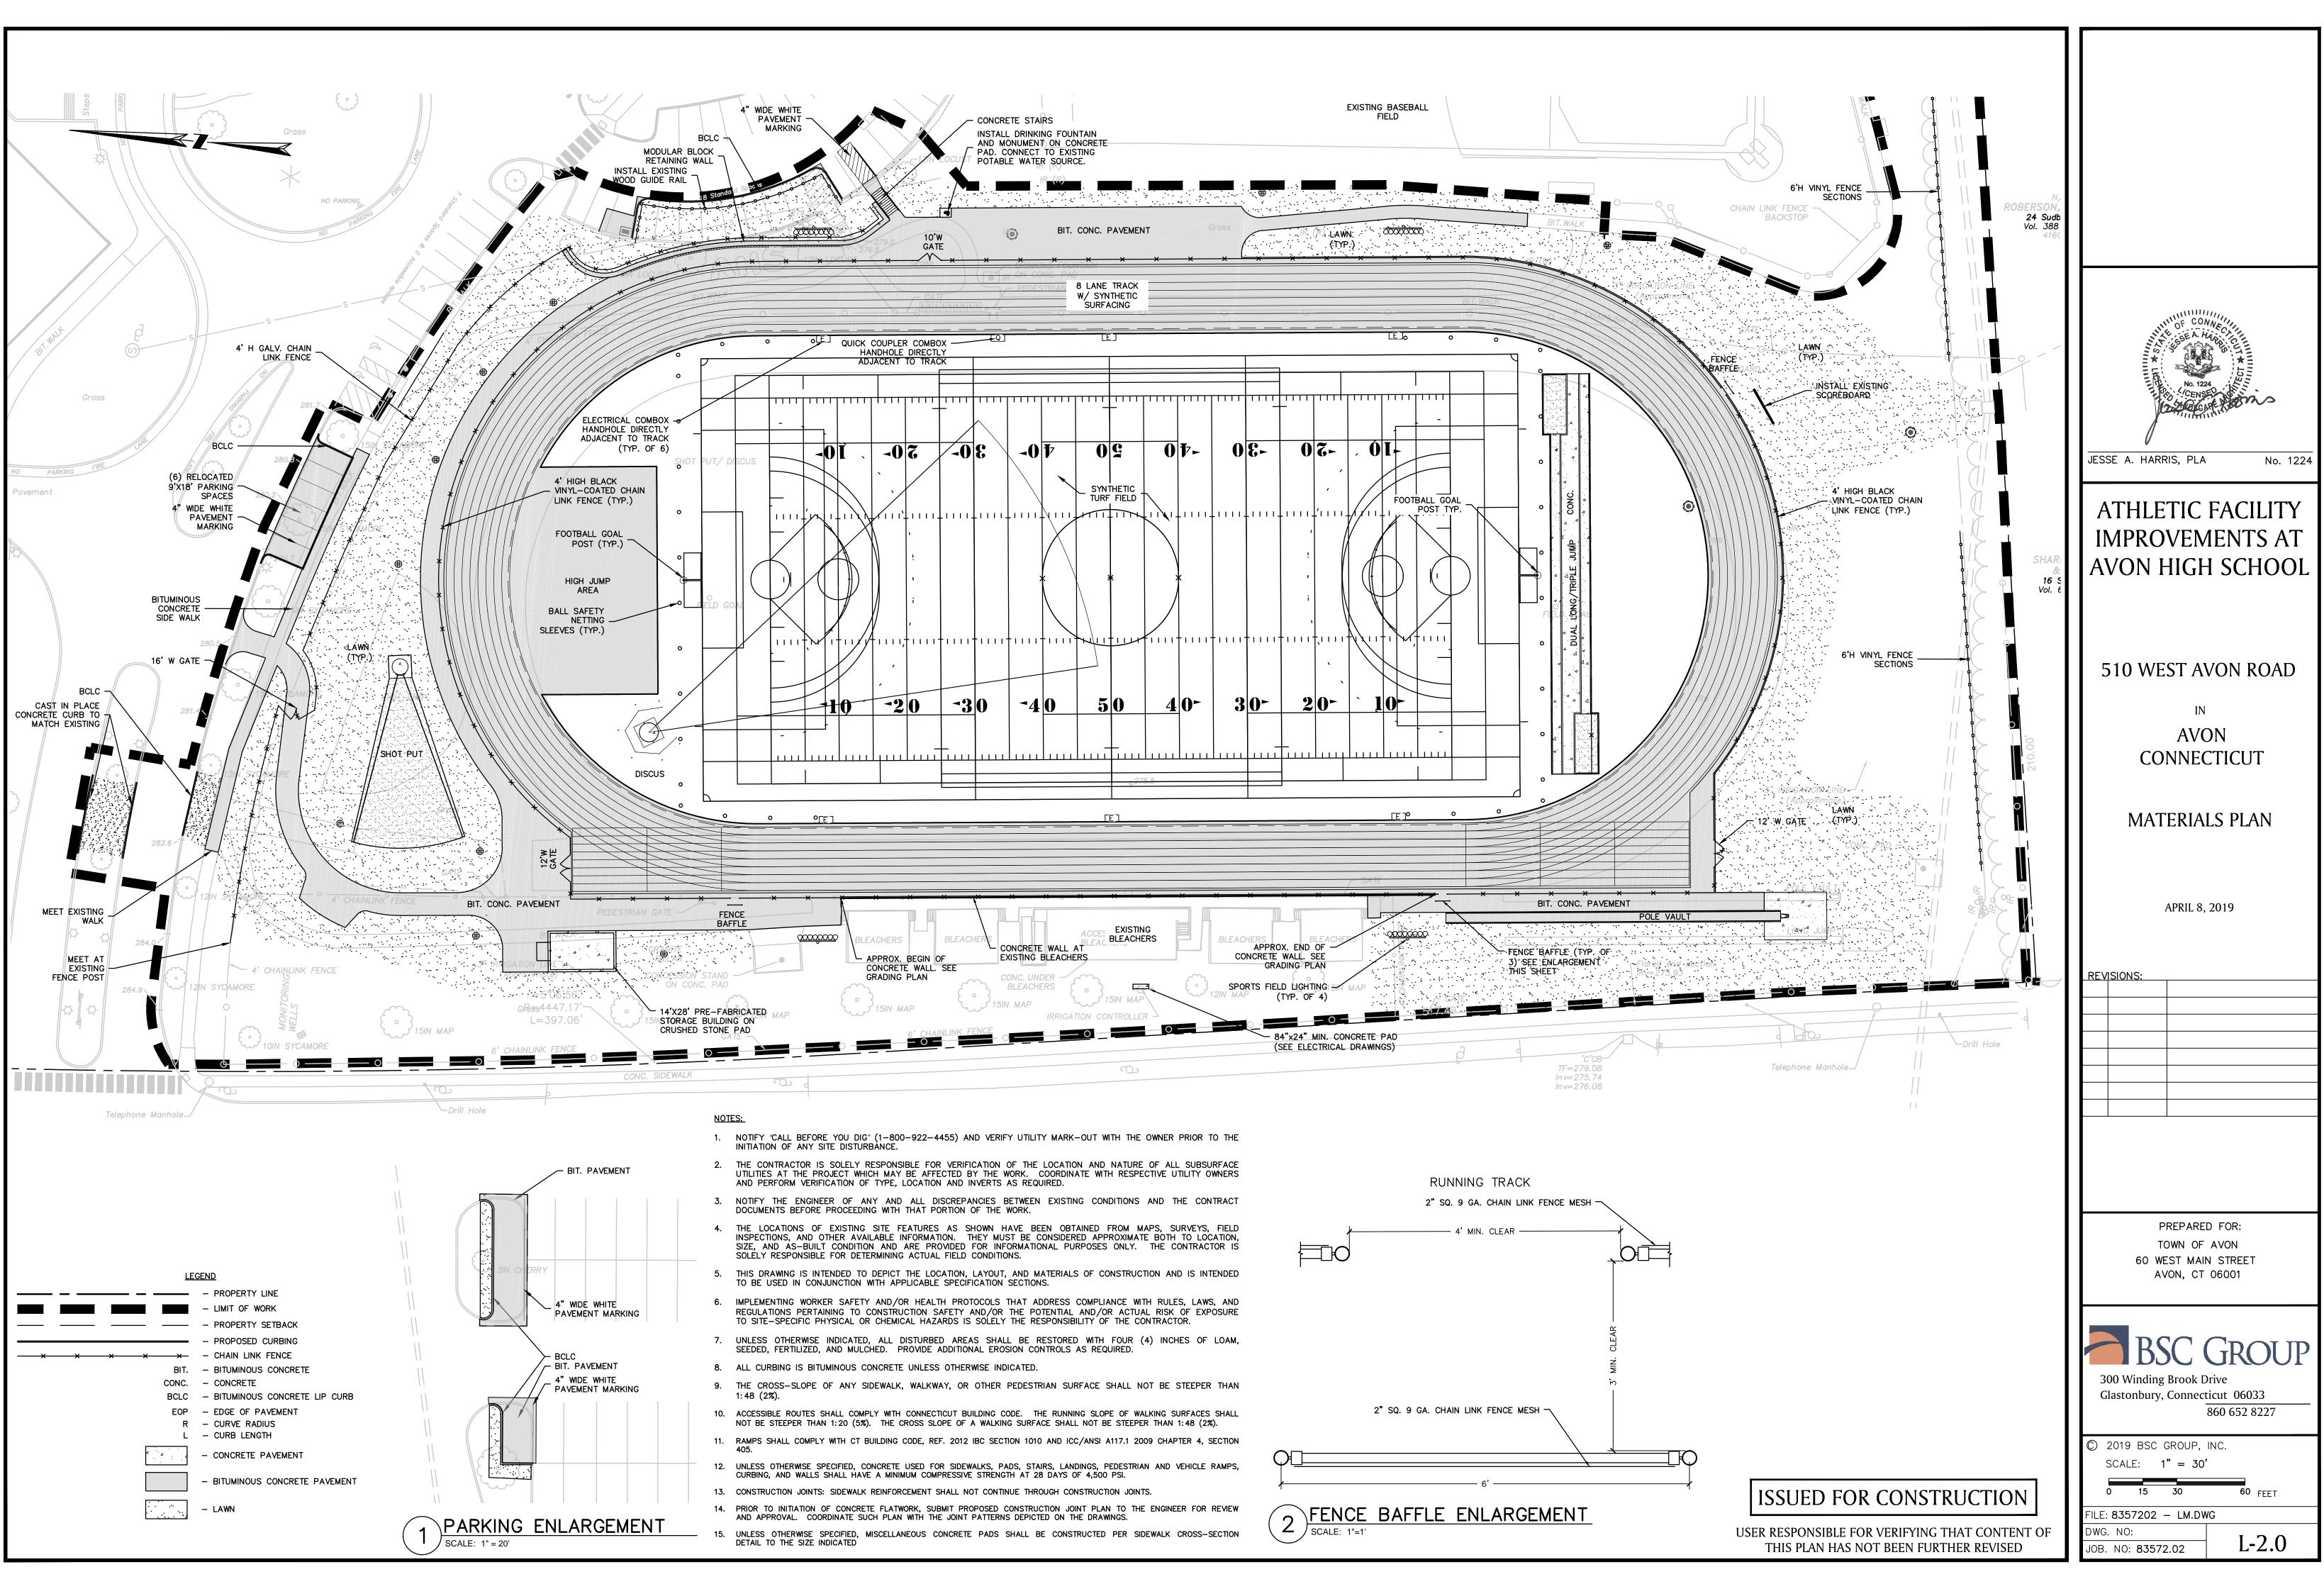
1. TEAM AREAS TO BE PAINTED BY OTHERS (N.I.C.)




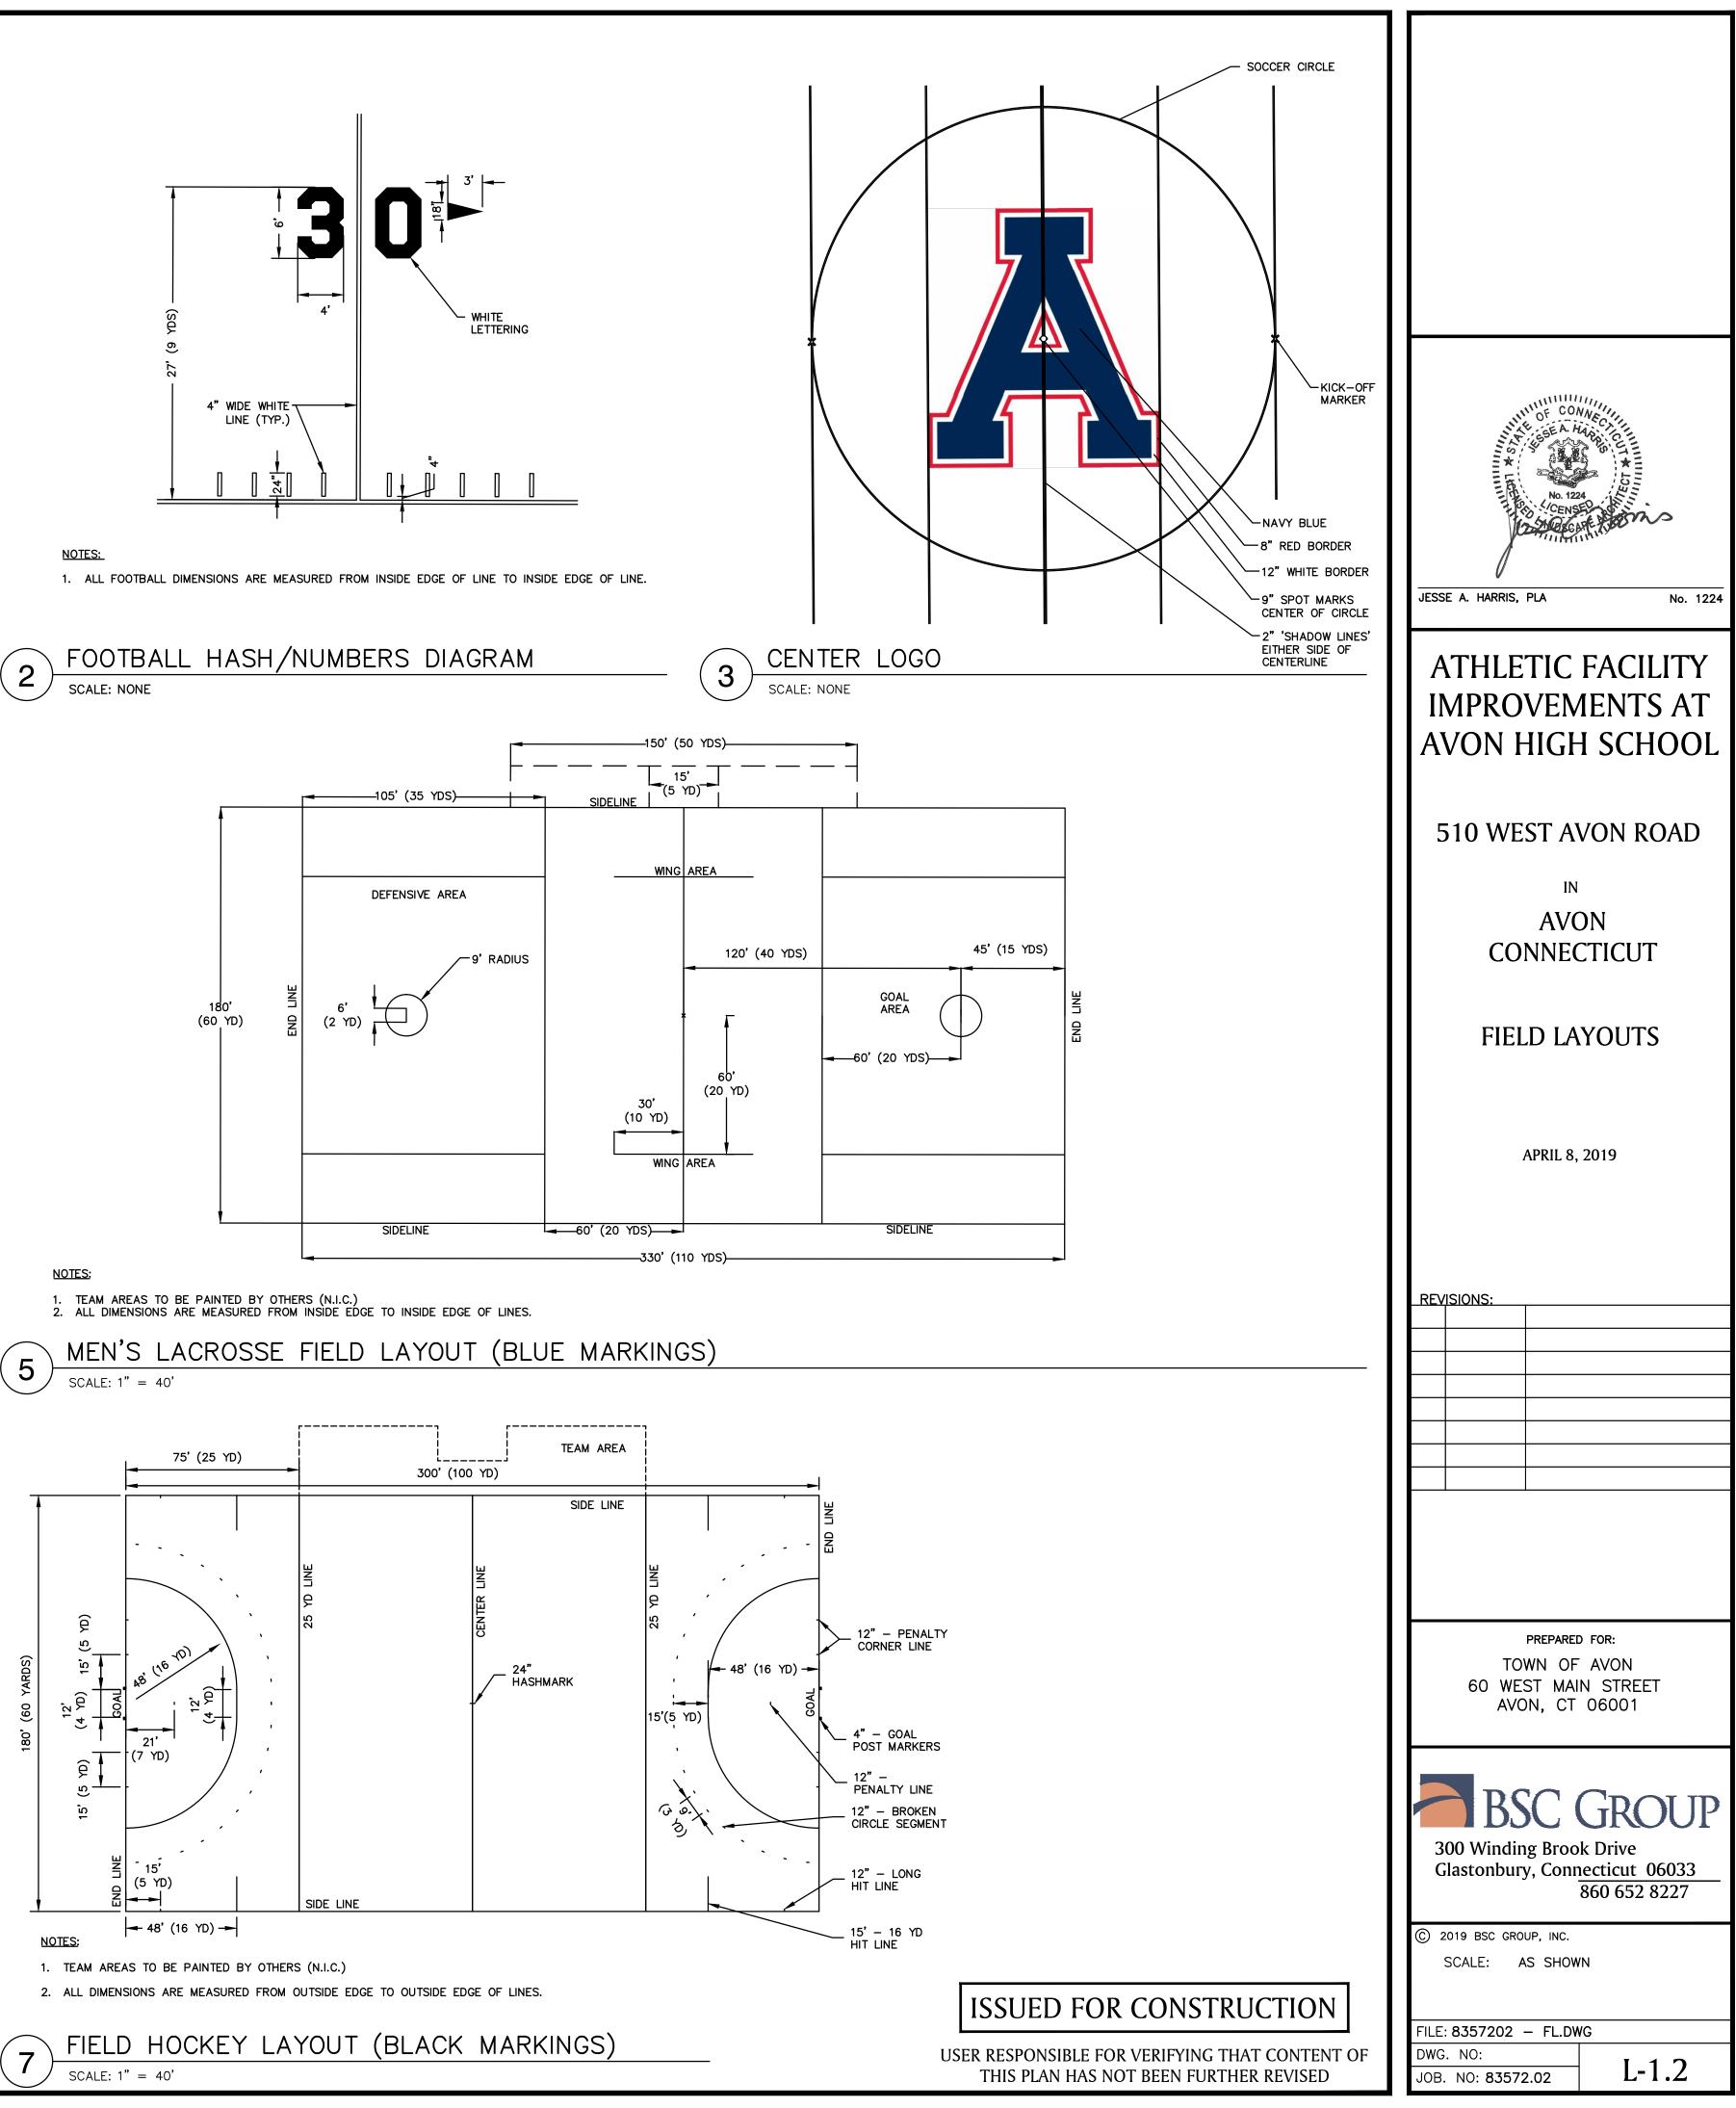



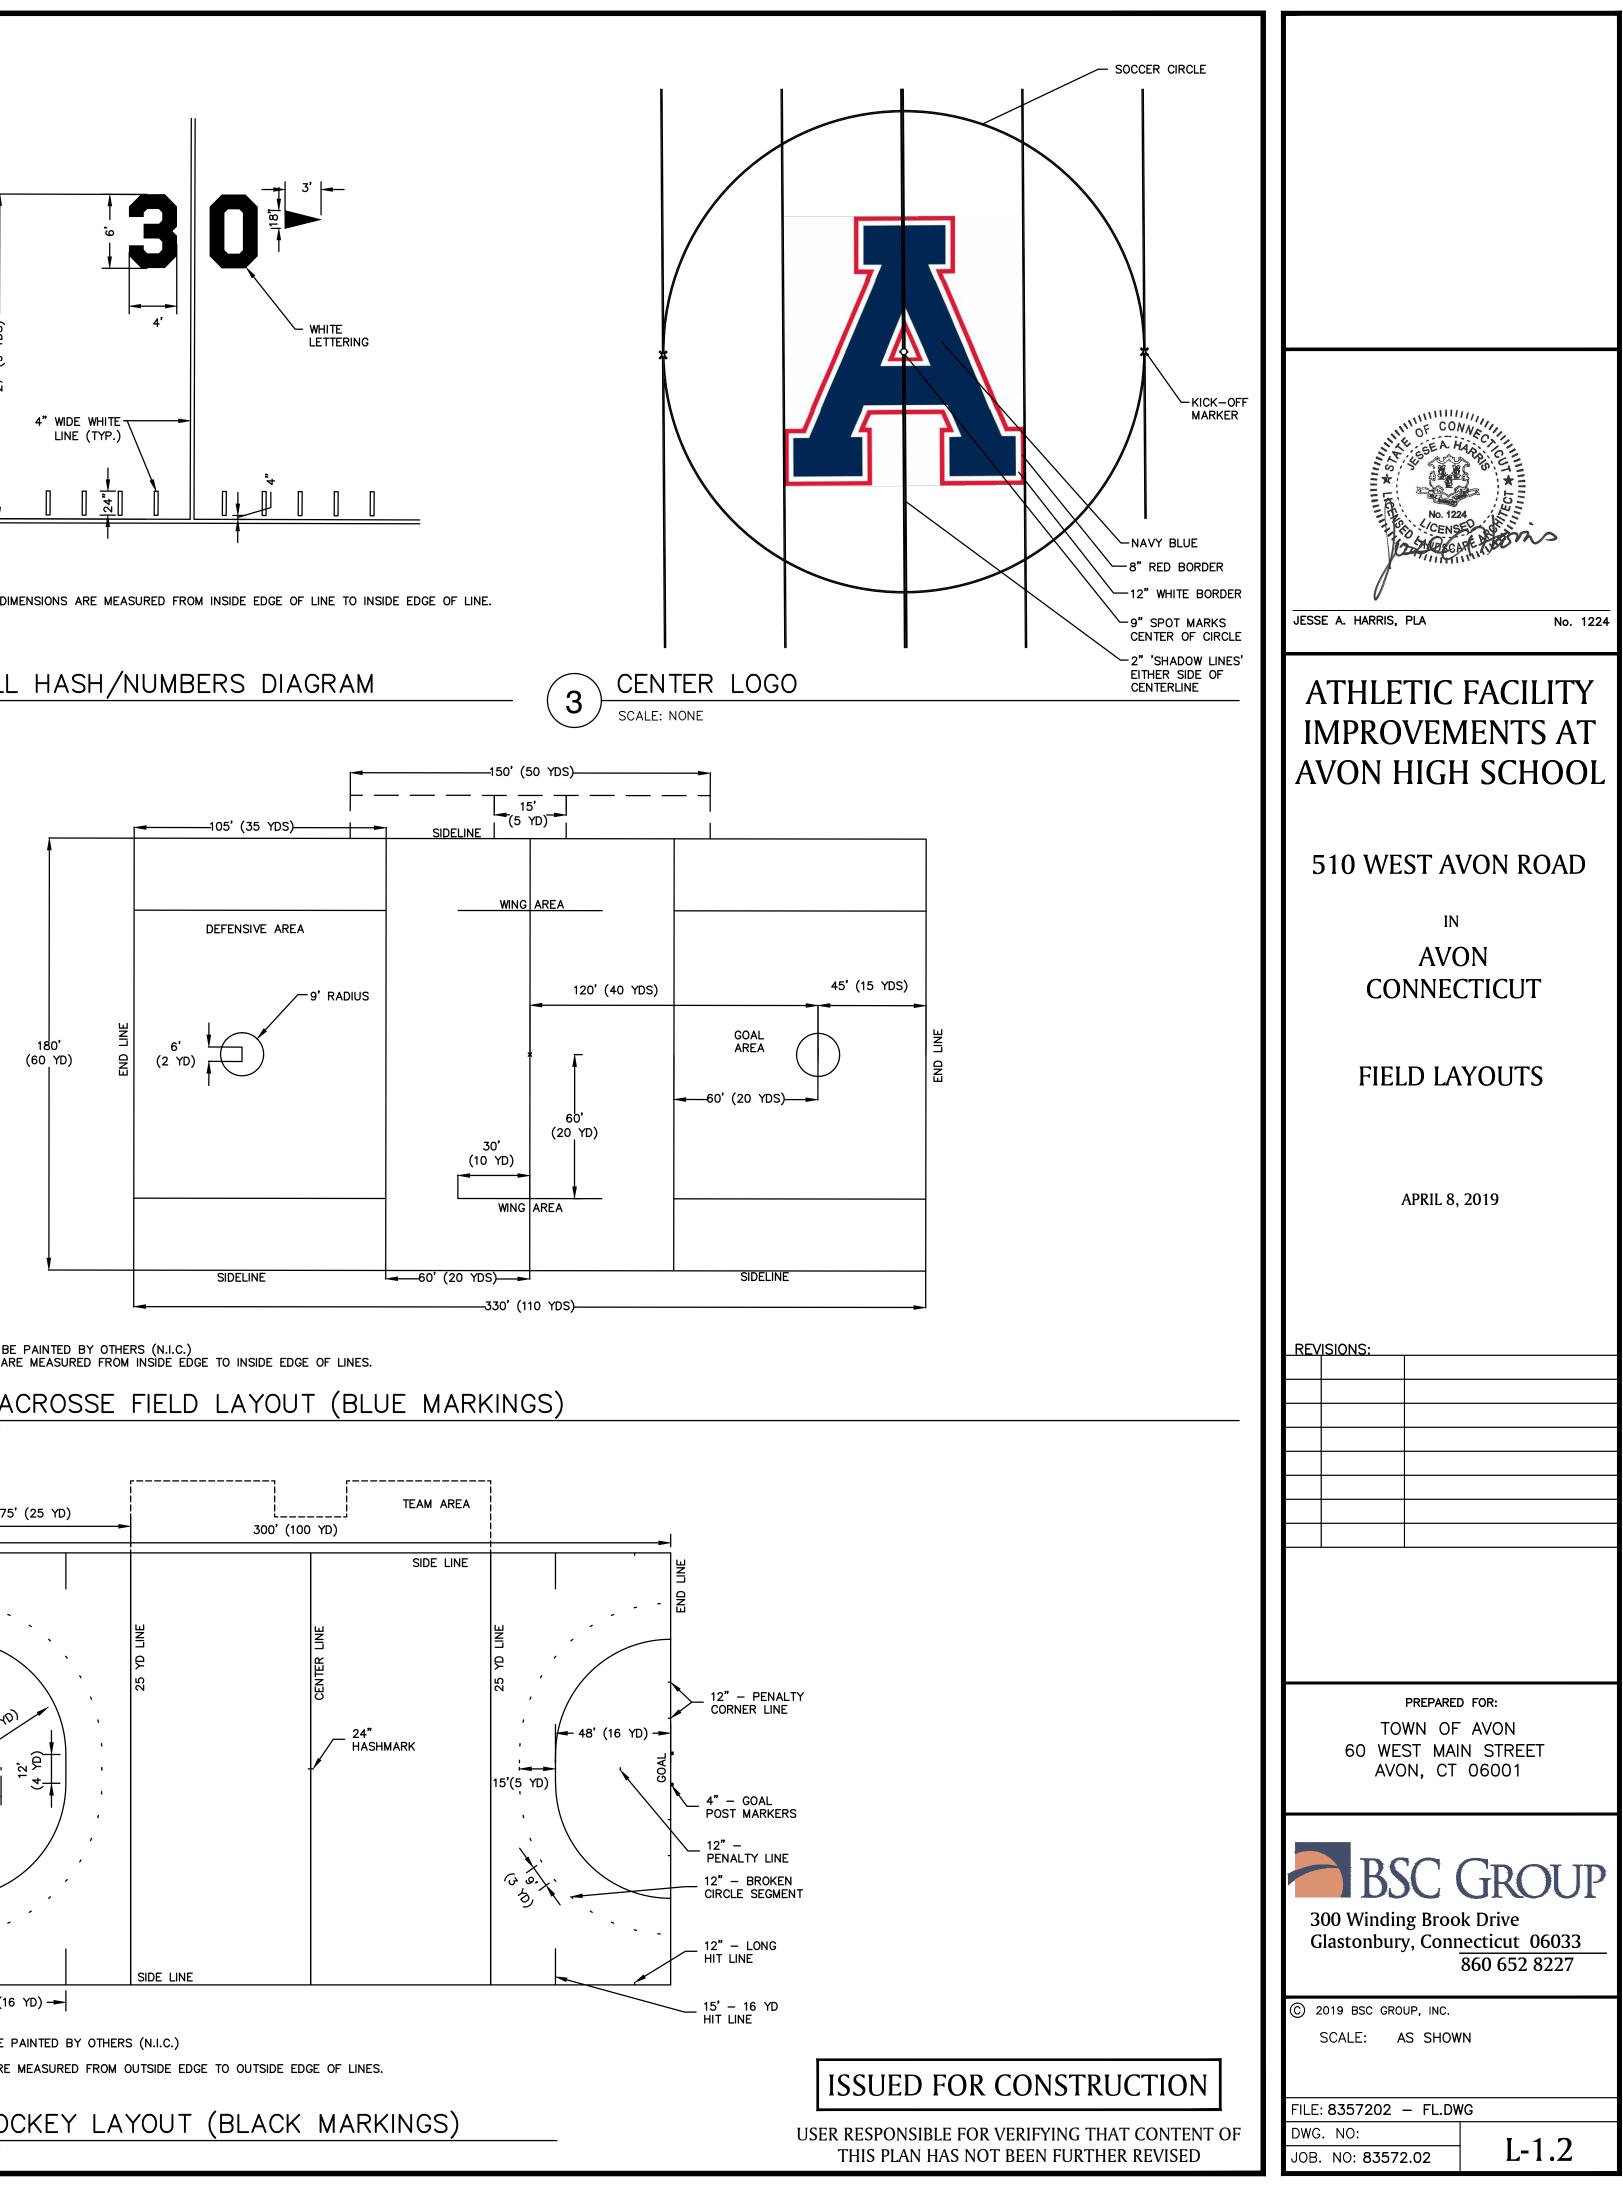

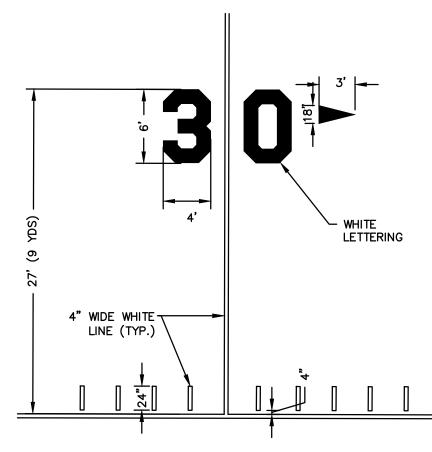

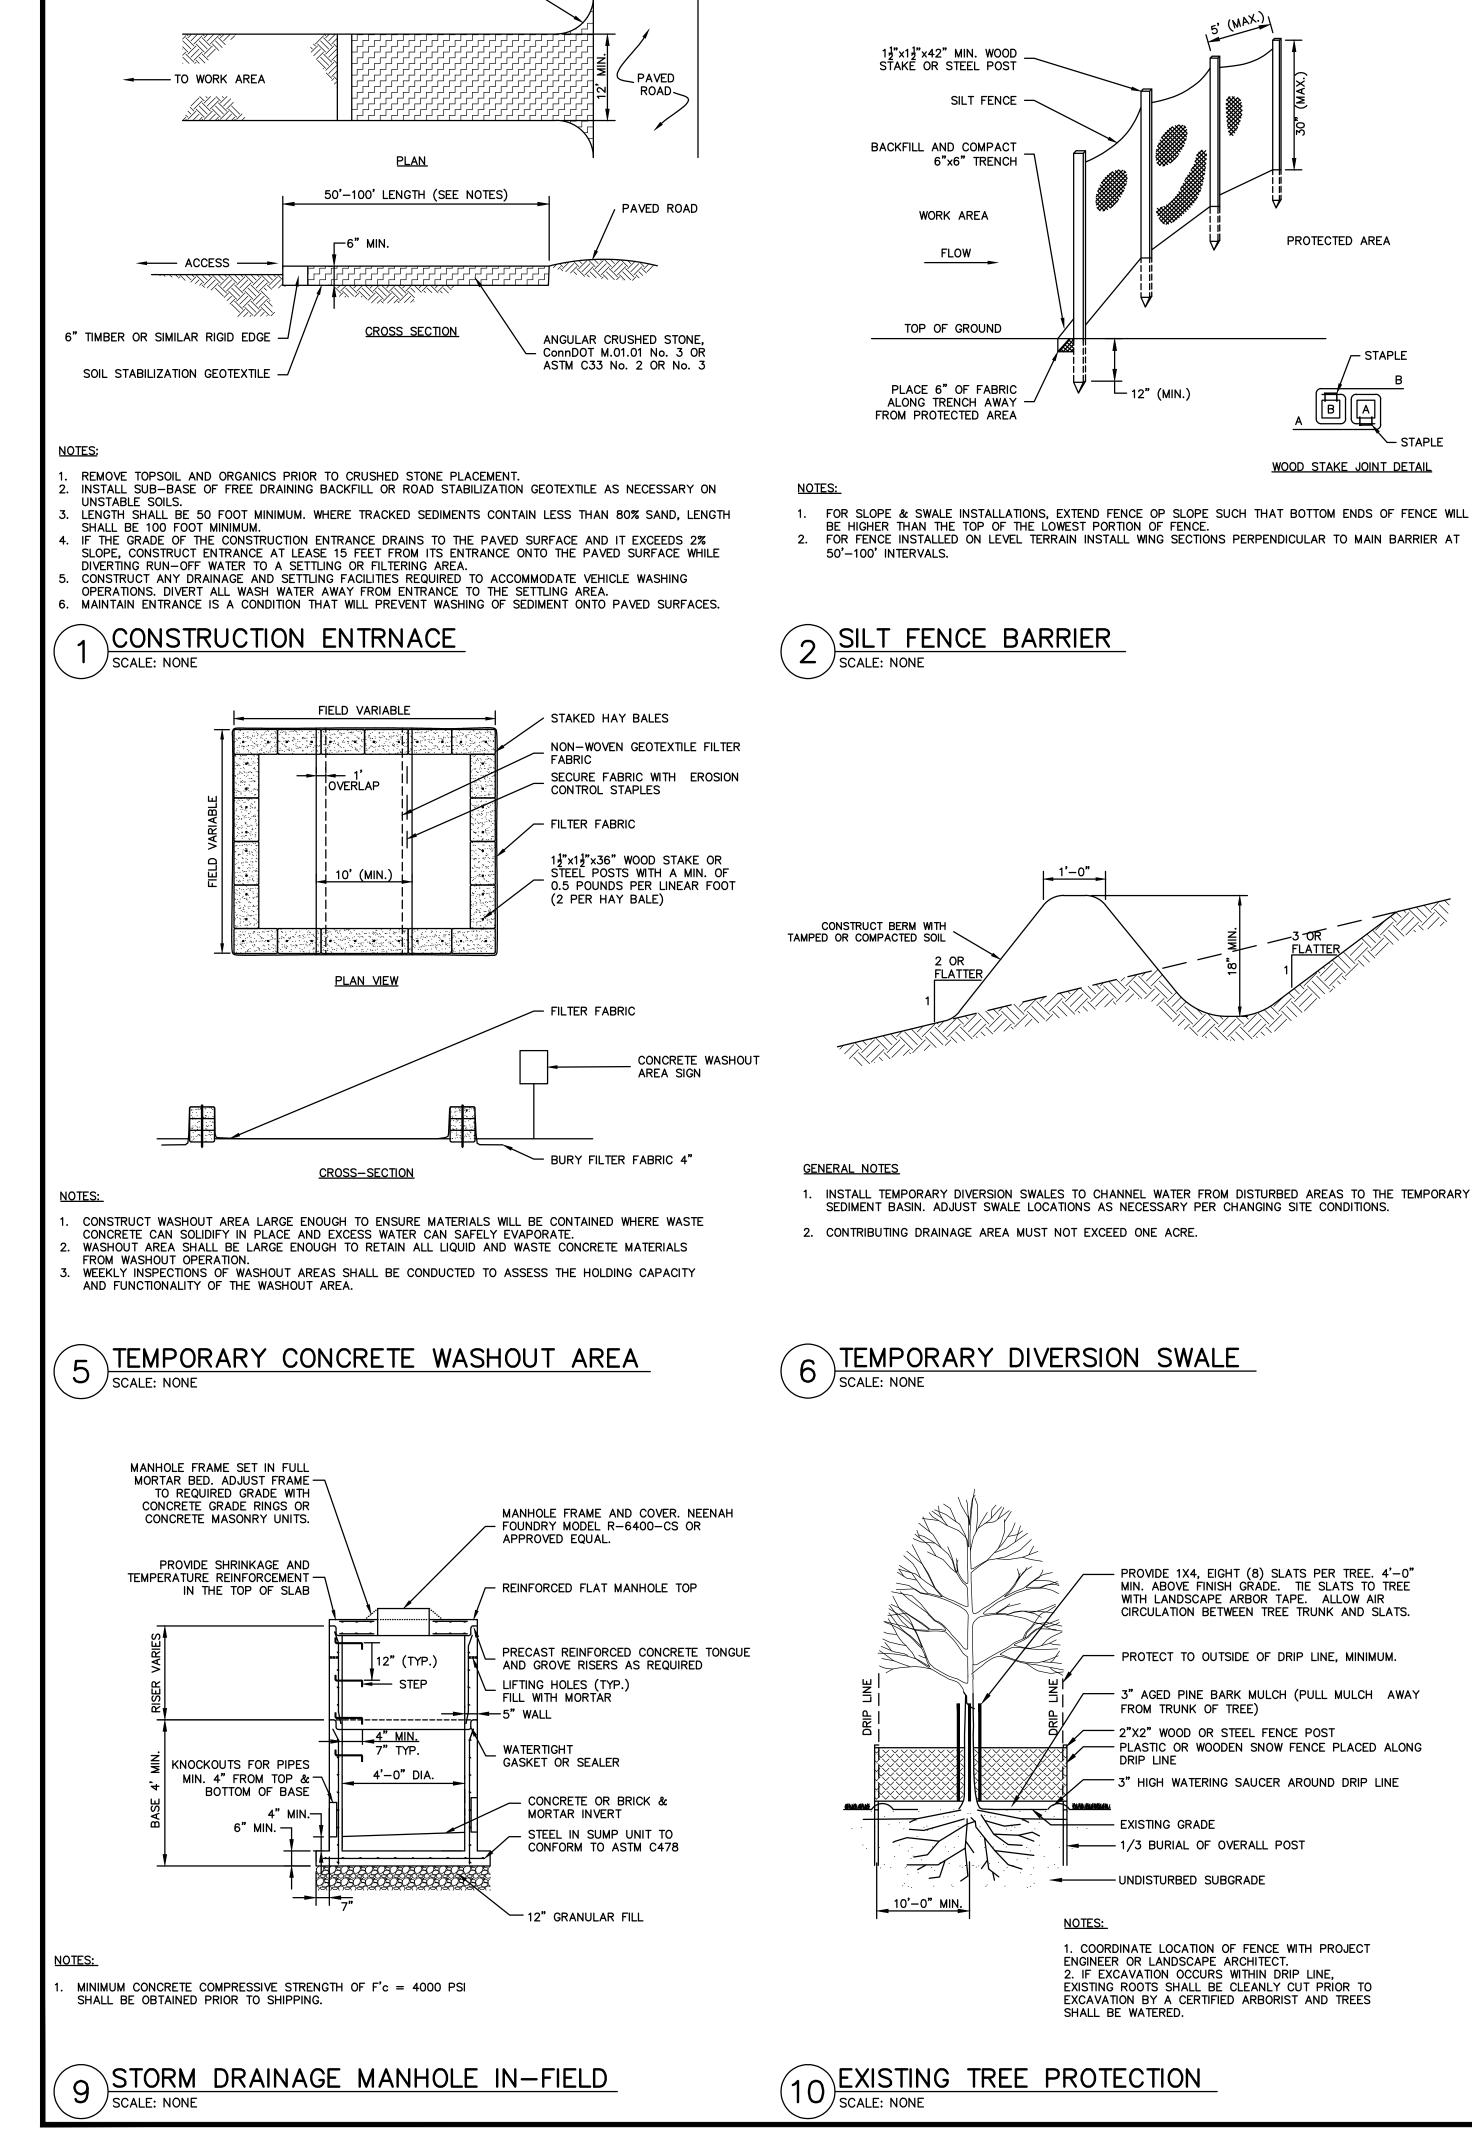

10' MIN. RADIUS



1. COORDINATE LOCATION OF FENCE WITH PROJECT ENGINEER OR LANDSCAPE ARCHITECT. 2. IF EXCAVATION OCCURS WITHIN DRIP LINE, EXISTING ROOTS SHALL BE CLEANLY CUT PRIOR TO EXCAVATION BY A CERTIFIED ARBORIST AND TREES

<u>NOTES:</u> 1. CAN BE MADE WITH PVC AND "T."

1

SCALE: NONE

₹ 12" (TYP.) (TYP.) กกกก่ากกกกก OUTLET -***** COMPACTED SUBGRADE

AREA DRAIN (HDPE OR PVC)

- 12" SUMP TO BE PROVIDED PLUG

- CAST IRON GRATE

- CONCRETE SLAB

- FINISH GRADE

- RISER PIPE (HDPE OR PVC)

BACKFILL MATERIAL SHALL

IN 6" LIFTS AROUND DRAIN

BE CRUSHED STONE OR SCREENED GRAVEL TAMPED

8

.½" DROP

2'-8¾"

4'-0"

<u>5'−4"</u>


FRONT VIEW


- ABOVE THE BOTTOM OF PERVIOUS BACKFILL. 4. WALL THICKNESS OF ALL CB'S OVER 10' DEEP SHALL BE INCREASED TO 12" THICK. INSIDE DIMENSION SHALL REMAIN THE SAME. (12" THICKNESS WILL START AFTER THE FIRST 10'). 5. MINIMUM CONCRETE COMPRESSIVE STRENGTH OF F'c = 4000 PSI SHALL BE OBTAINED PRIOR TO SHIPPING. TYPE "C-L" CATCH BASIN


APPROVED EQUAL.

SCALE: NONE

GENERAL NOTES

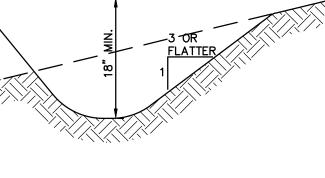

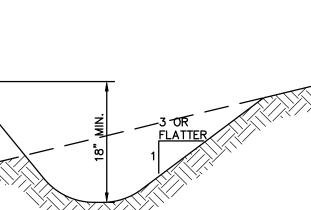

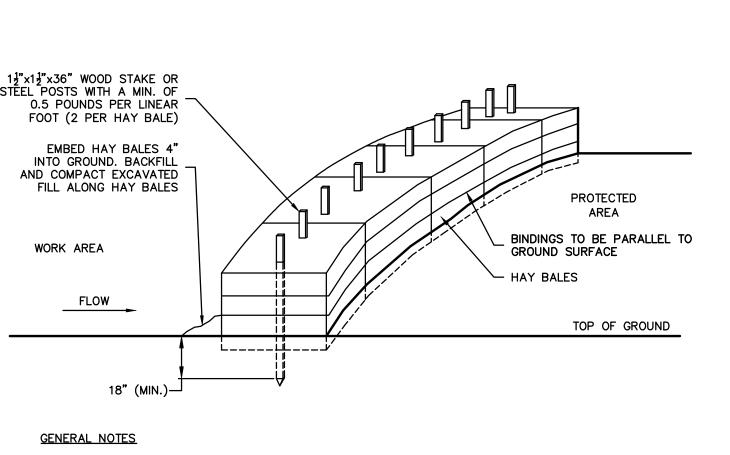

SCALE: NONE

(TYP.)

3)HAY BALE BARRIER

3'-0"

4'-4"

SIDE VIEW

-

1. FRAME AND GRATE SHALL BE CONSTRUCTED PER SPECIFICATIONS.

AS DIRECTED

FINISHED GRADE MAY VARY ADJACENT TO CATCH BASIN

 $- - \frac{(\text{TYP.})}{-} + \frac{1}{2} \text{ DROP}$

- WEIGHT HELD TOGETHER BY TWINE OR WIRE.

- 2. PLACE HAY BALES ON CONTOUR AND WING THE LAST HAY BALES UP SLOPE SO THAT THE TOP OF

NSTALL PERVIOUS BACKF HIS ELEVATION FROM BC SUBBASE TO A MAX. DEF

- 12" CRUSHED STONE /

3. TO CONVEY SUBSURFACE DRAINAGE, OPENINGS SHALL BE FORMED IN THE FOUR WALLS AT OR IMMEDIATELY

2. ALL FACES OF STRUCTURES IN CONTACT WITH PAVEMENT SHALL BE COVERED WITH TAR PAPER OR

(TYP.)

- THE LAST SEVERAL HAY BALES ARE HIGHER THAN THE LINE OF HAY BALES.

- 3. DRIVE FIRST STAKE IN EACH BALE TOWARD THE PREVIOUSLY LAID BALE TO FORCE THEM TOGETHER.
- 4. PUT ONE HAY BALE PERPENDICULAR ALONG HAY BALE BARRIER EACH 100 FEET.

- 1. HAY BALES SHALL BE MADE OF HAY OR STRAW WITH 40 POUND MIN. WEIGHT AND 120 POUND MAX.


– STAPLE


STAPLE


PROTECTED AREA


WOOD STAKE JOINT DETAIL


1. FOR SLOPE & SWALE INSTALLATIONS, EXTEND FENCE OP SLOPE SUCH THAT BOTTOM ENDS OF FENCE WILL BE HIGHER THAN THE TOP OF THE LOWEST PORTION OF FENCE.

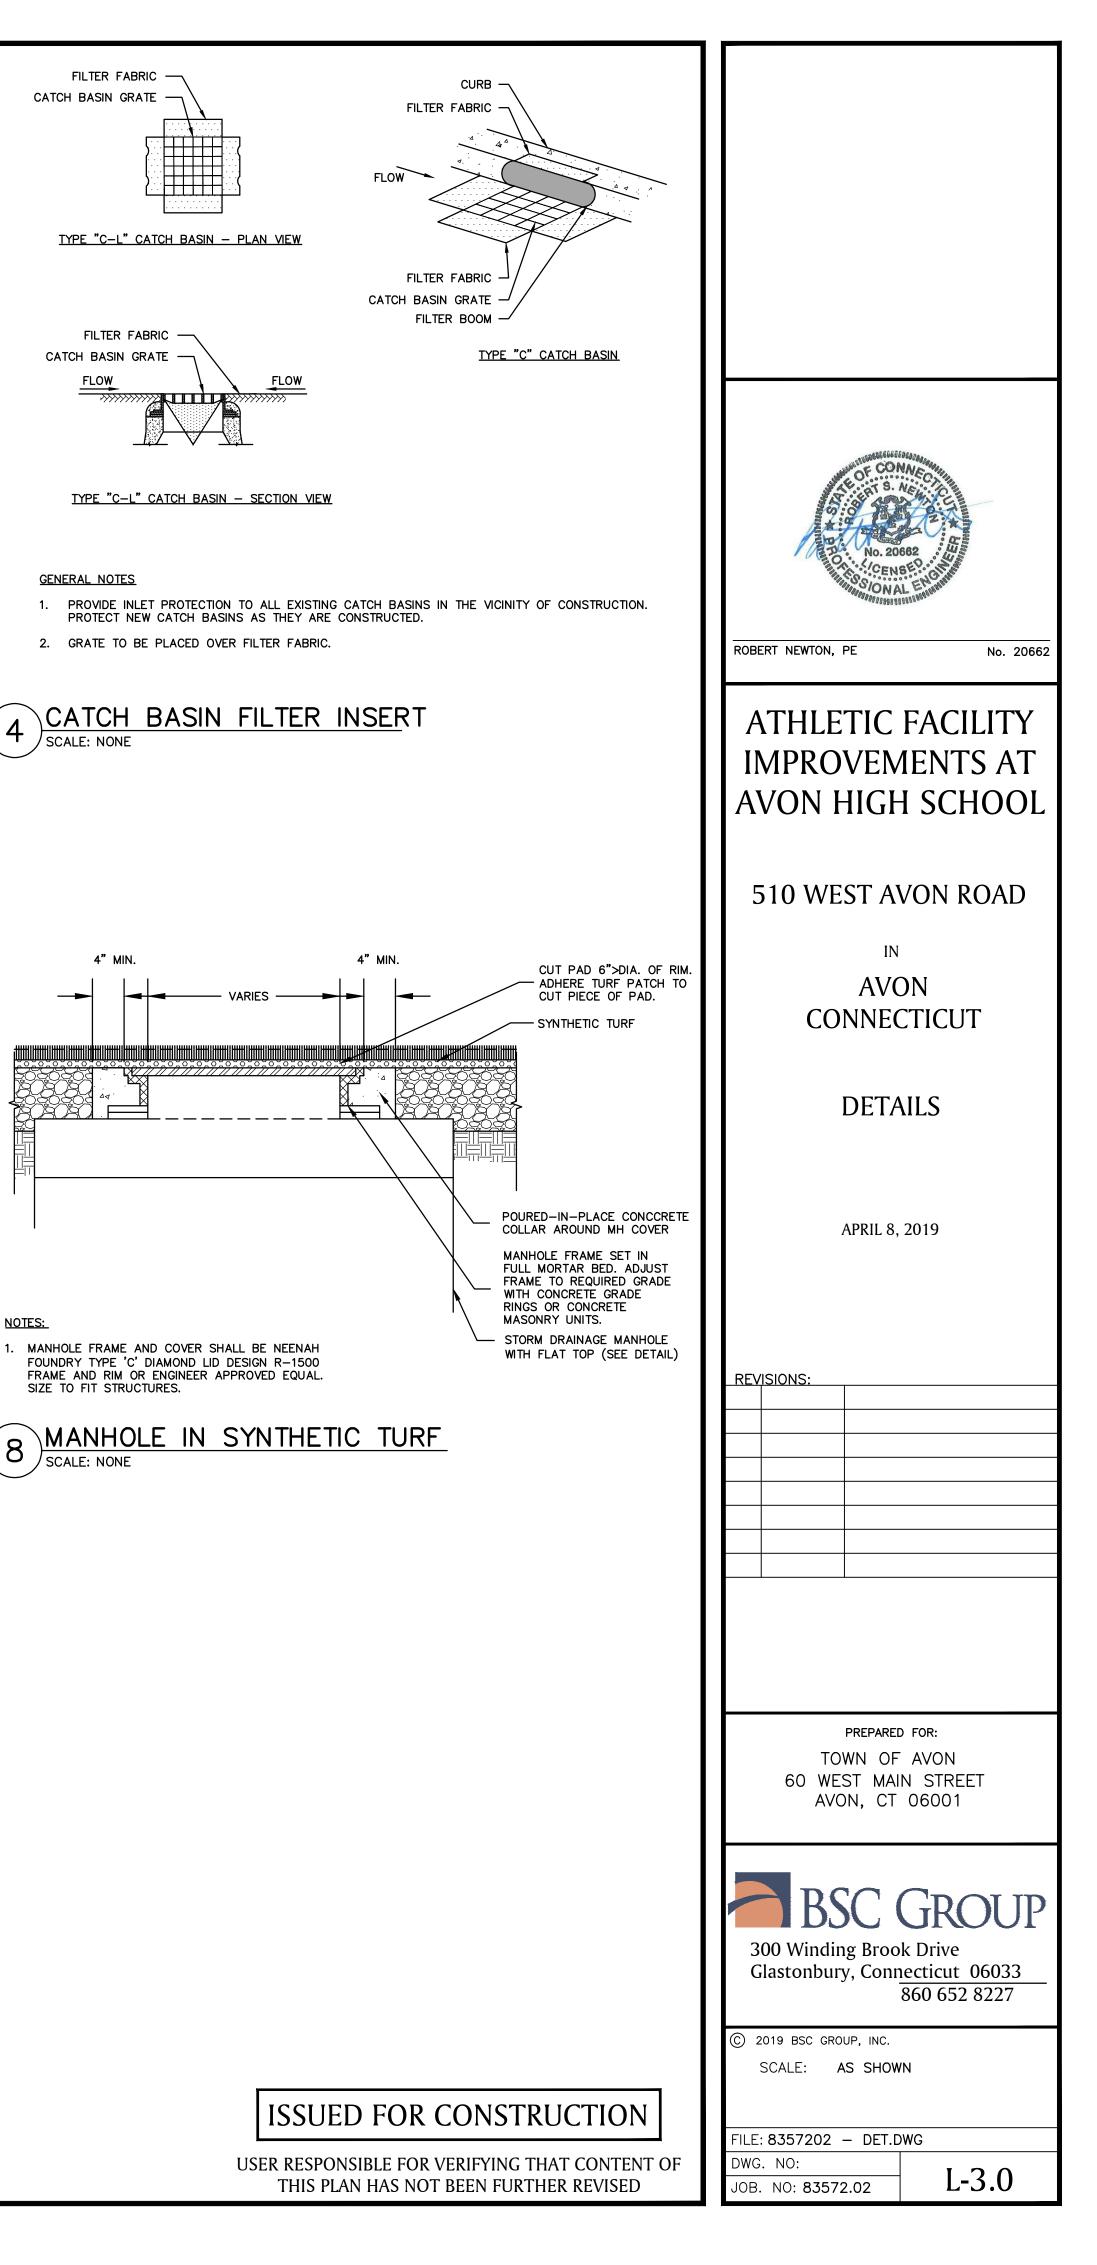


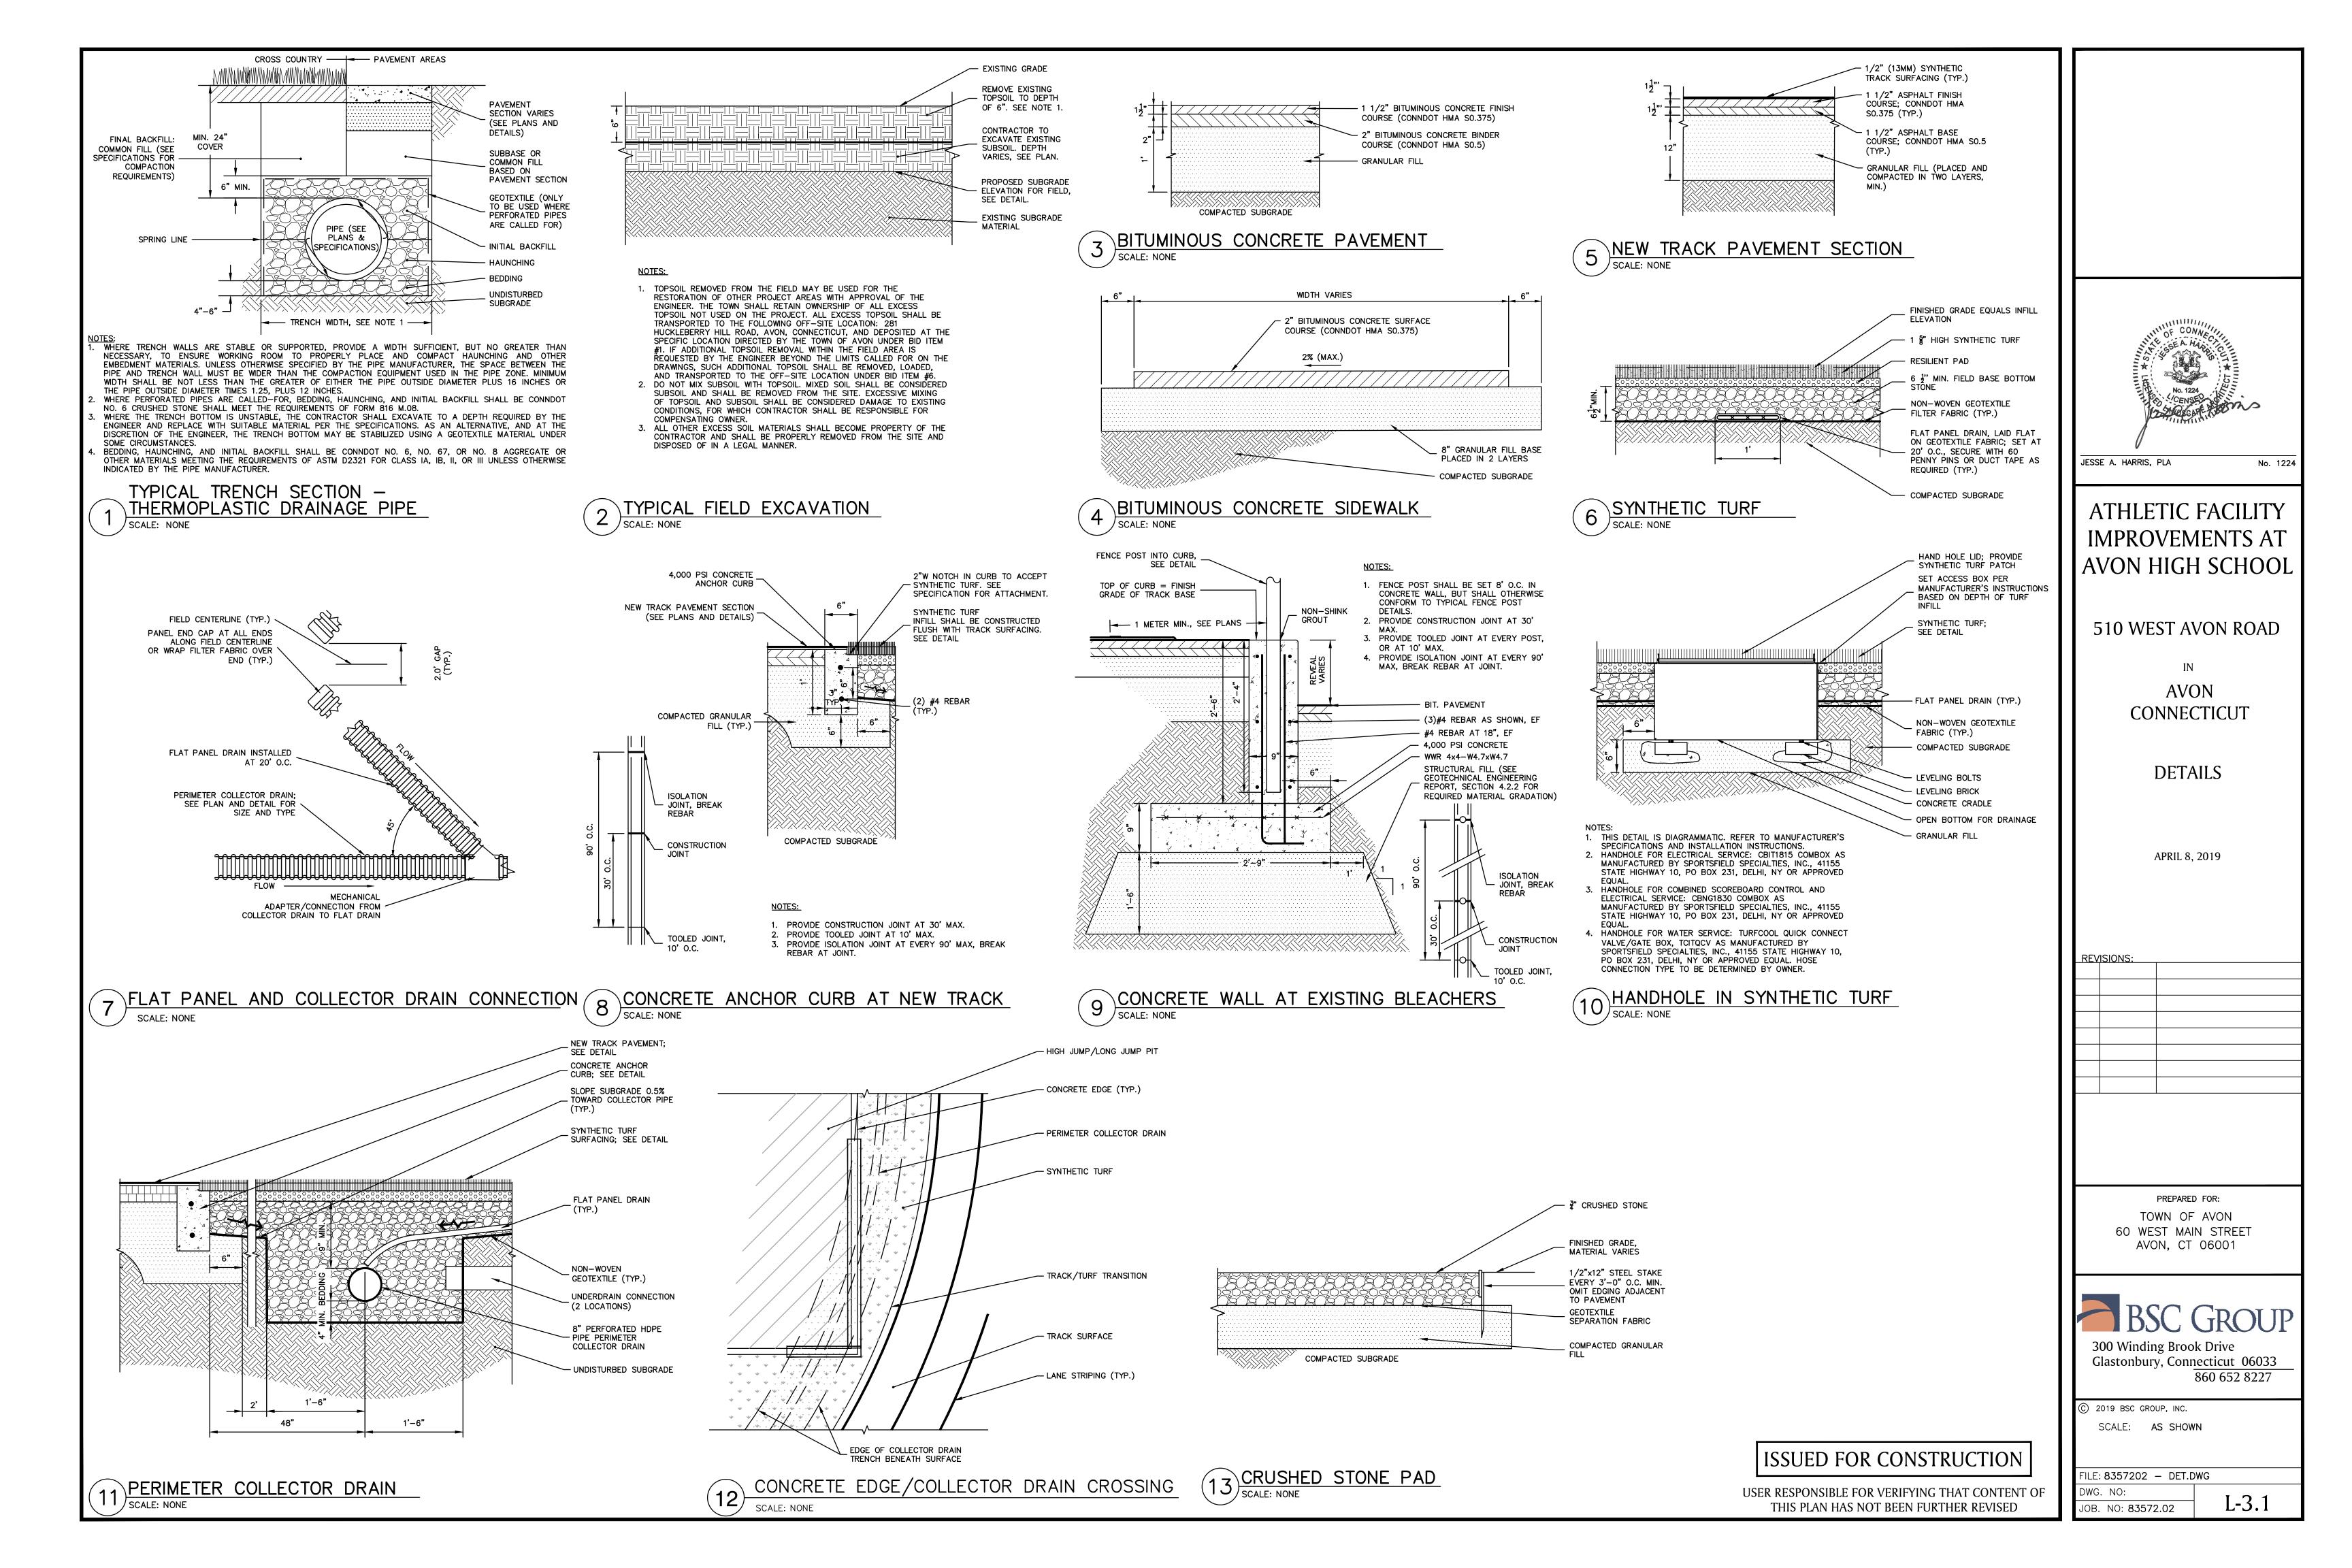

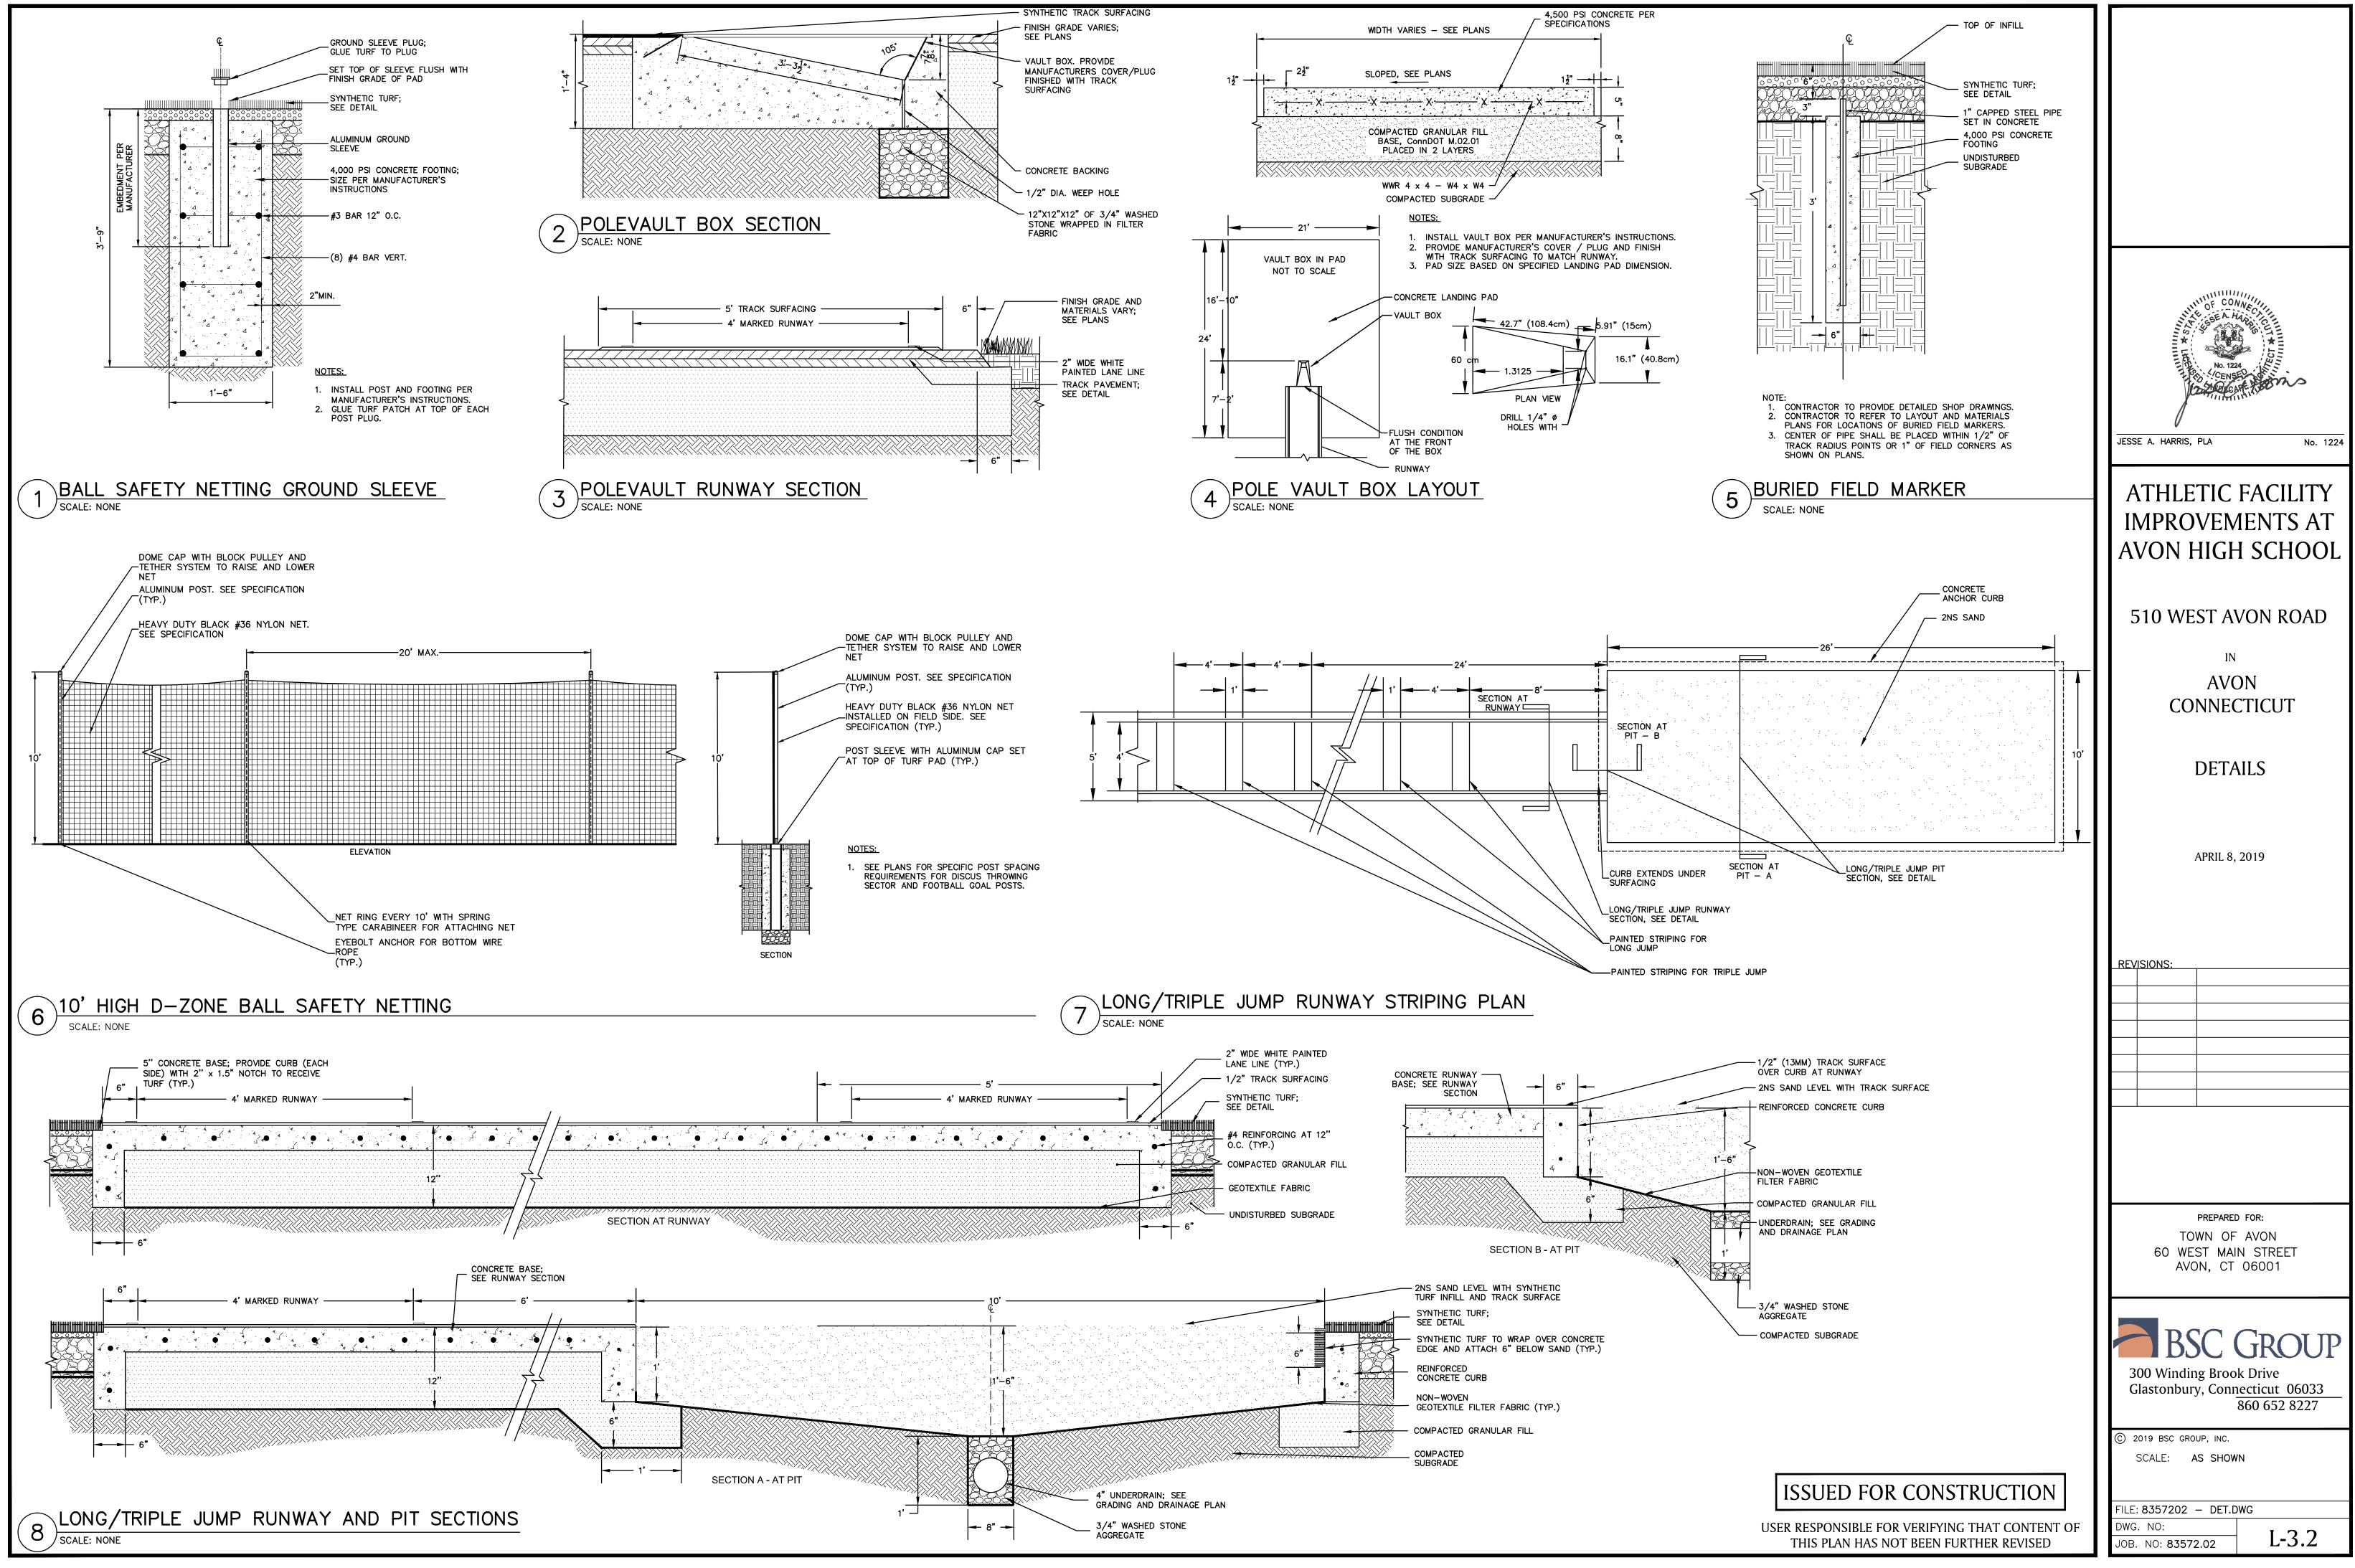

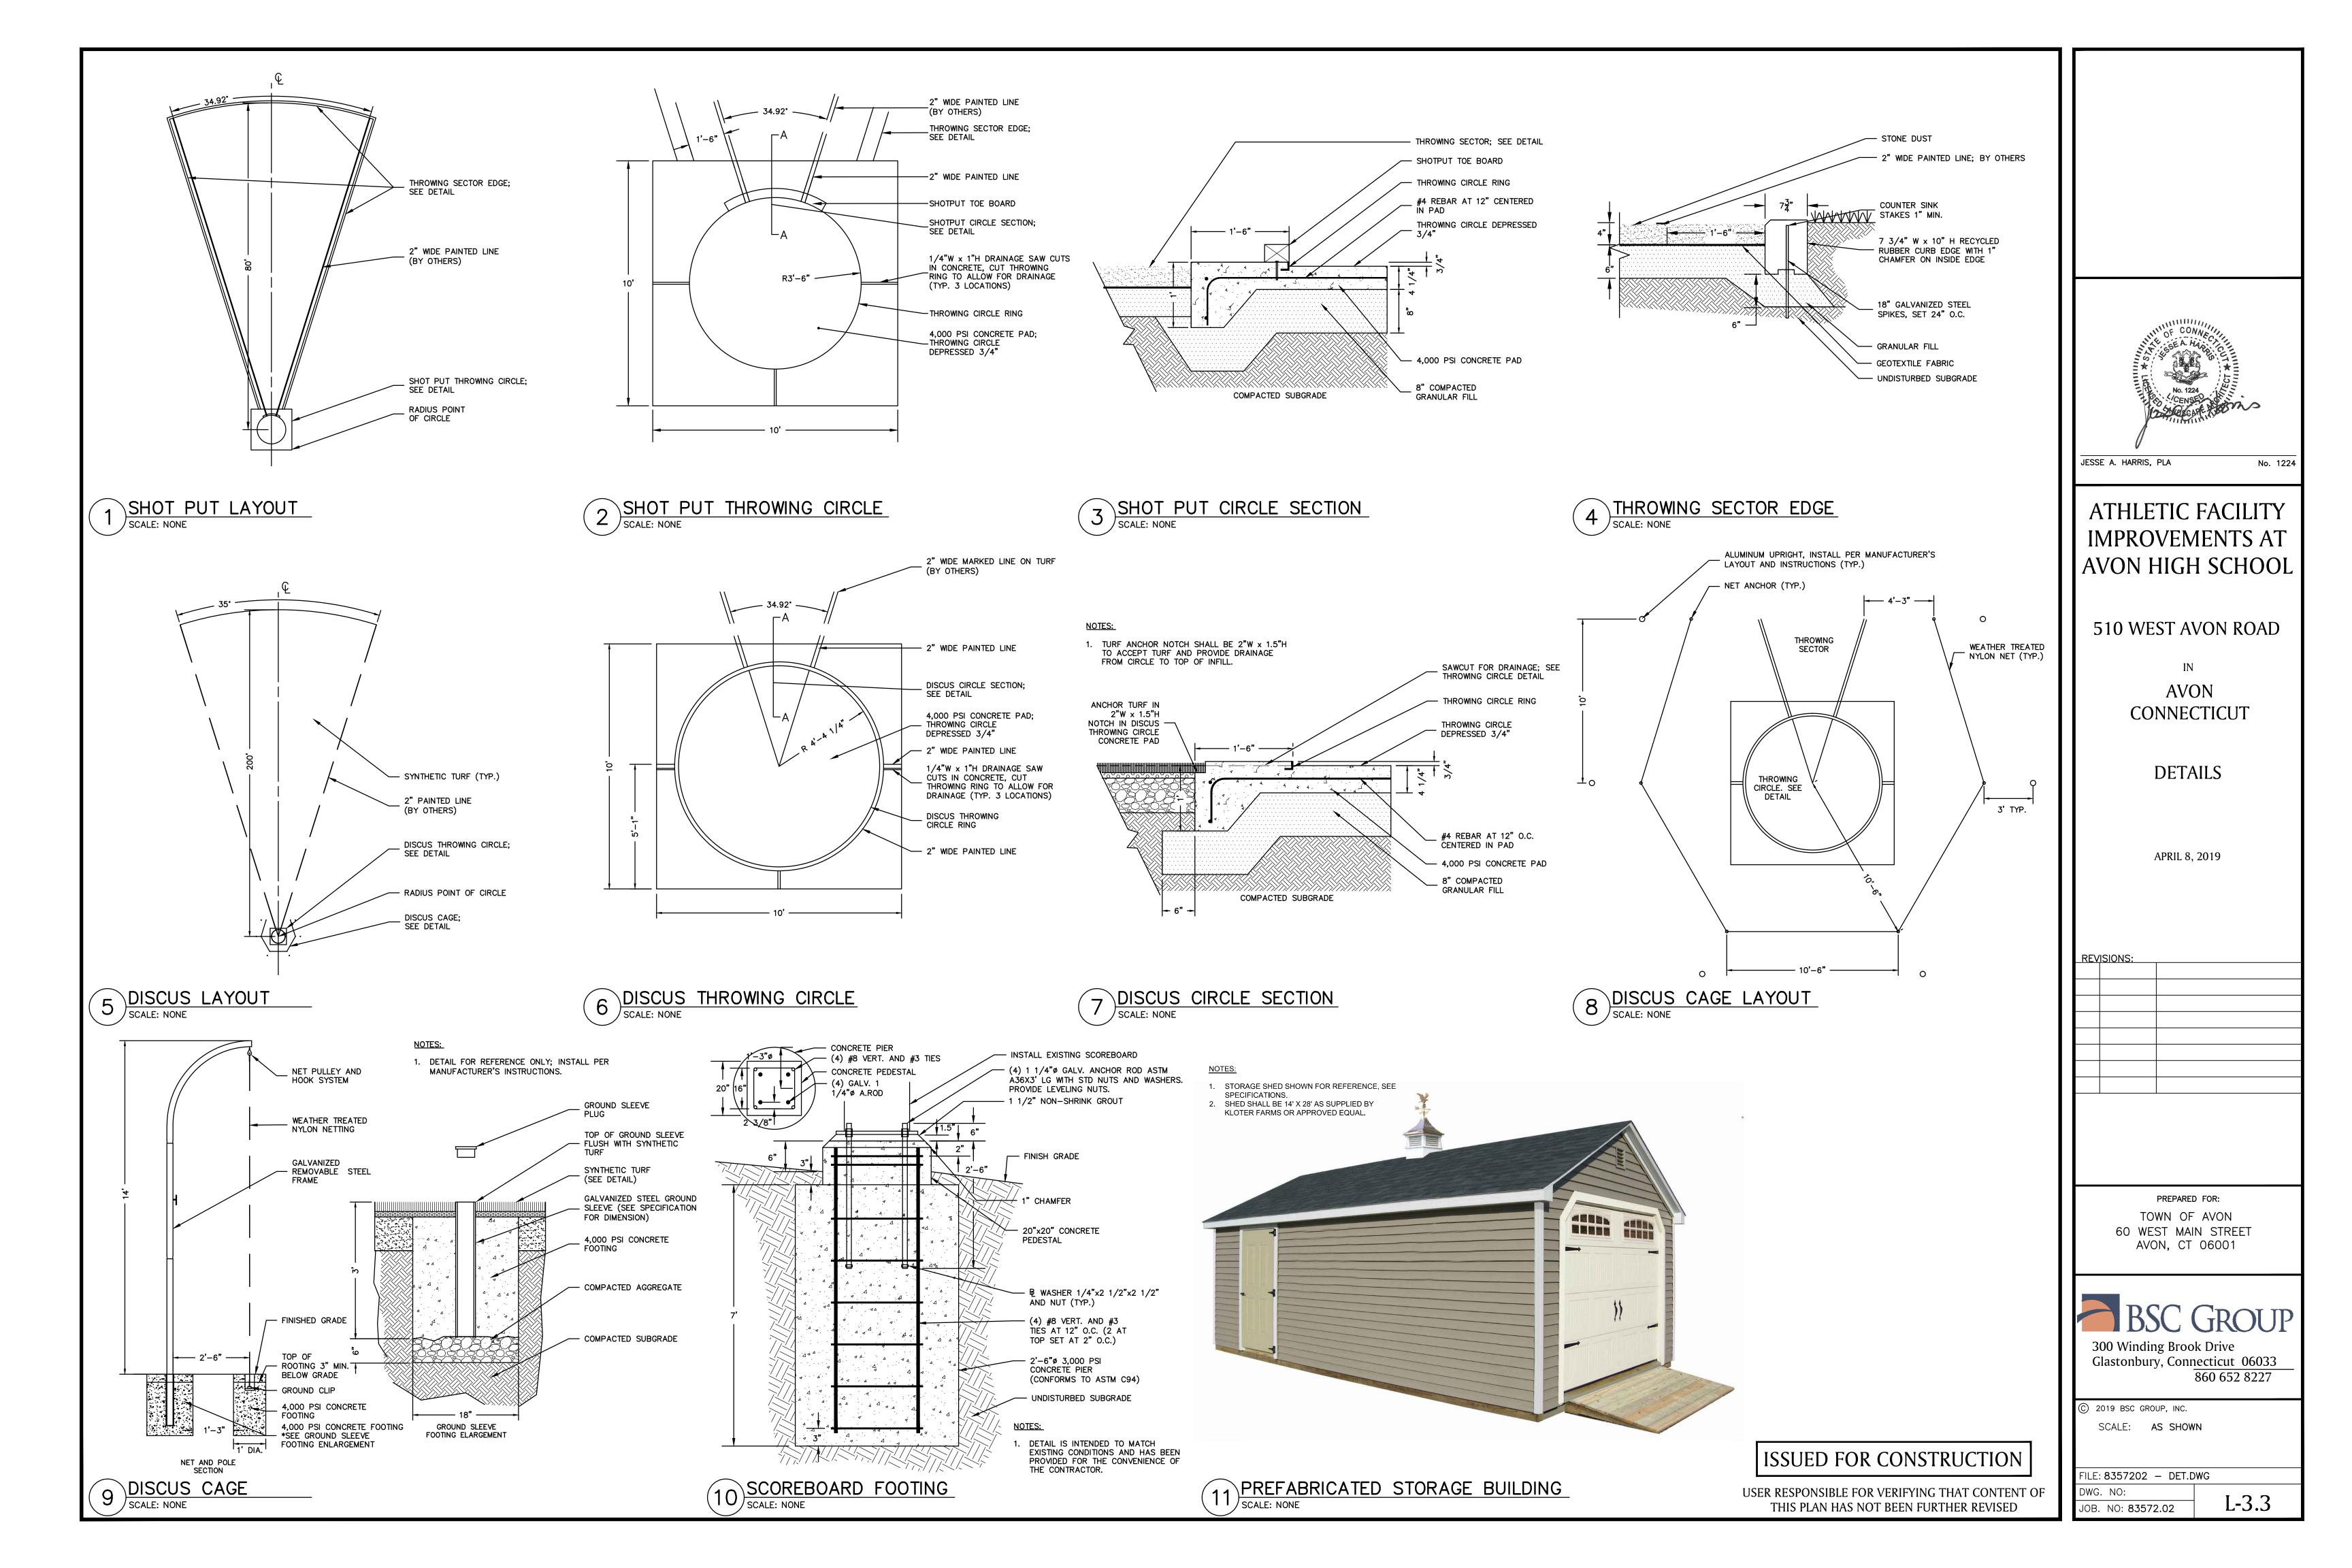

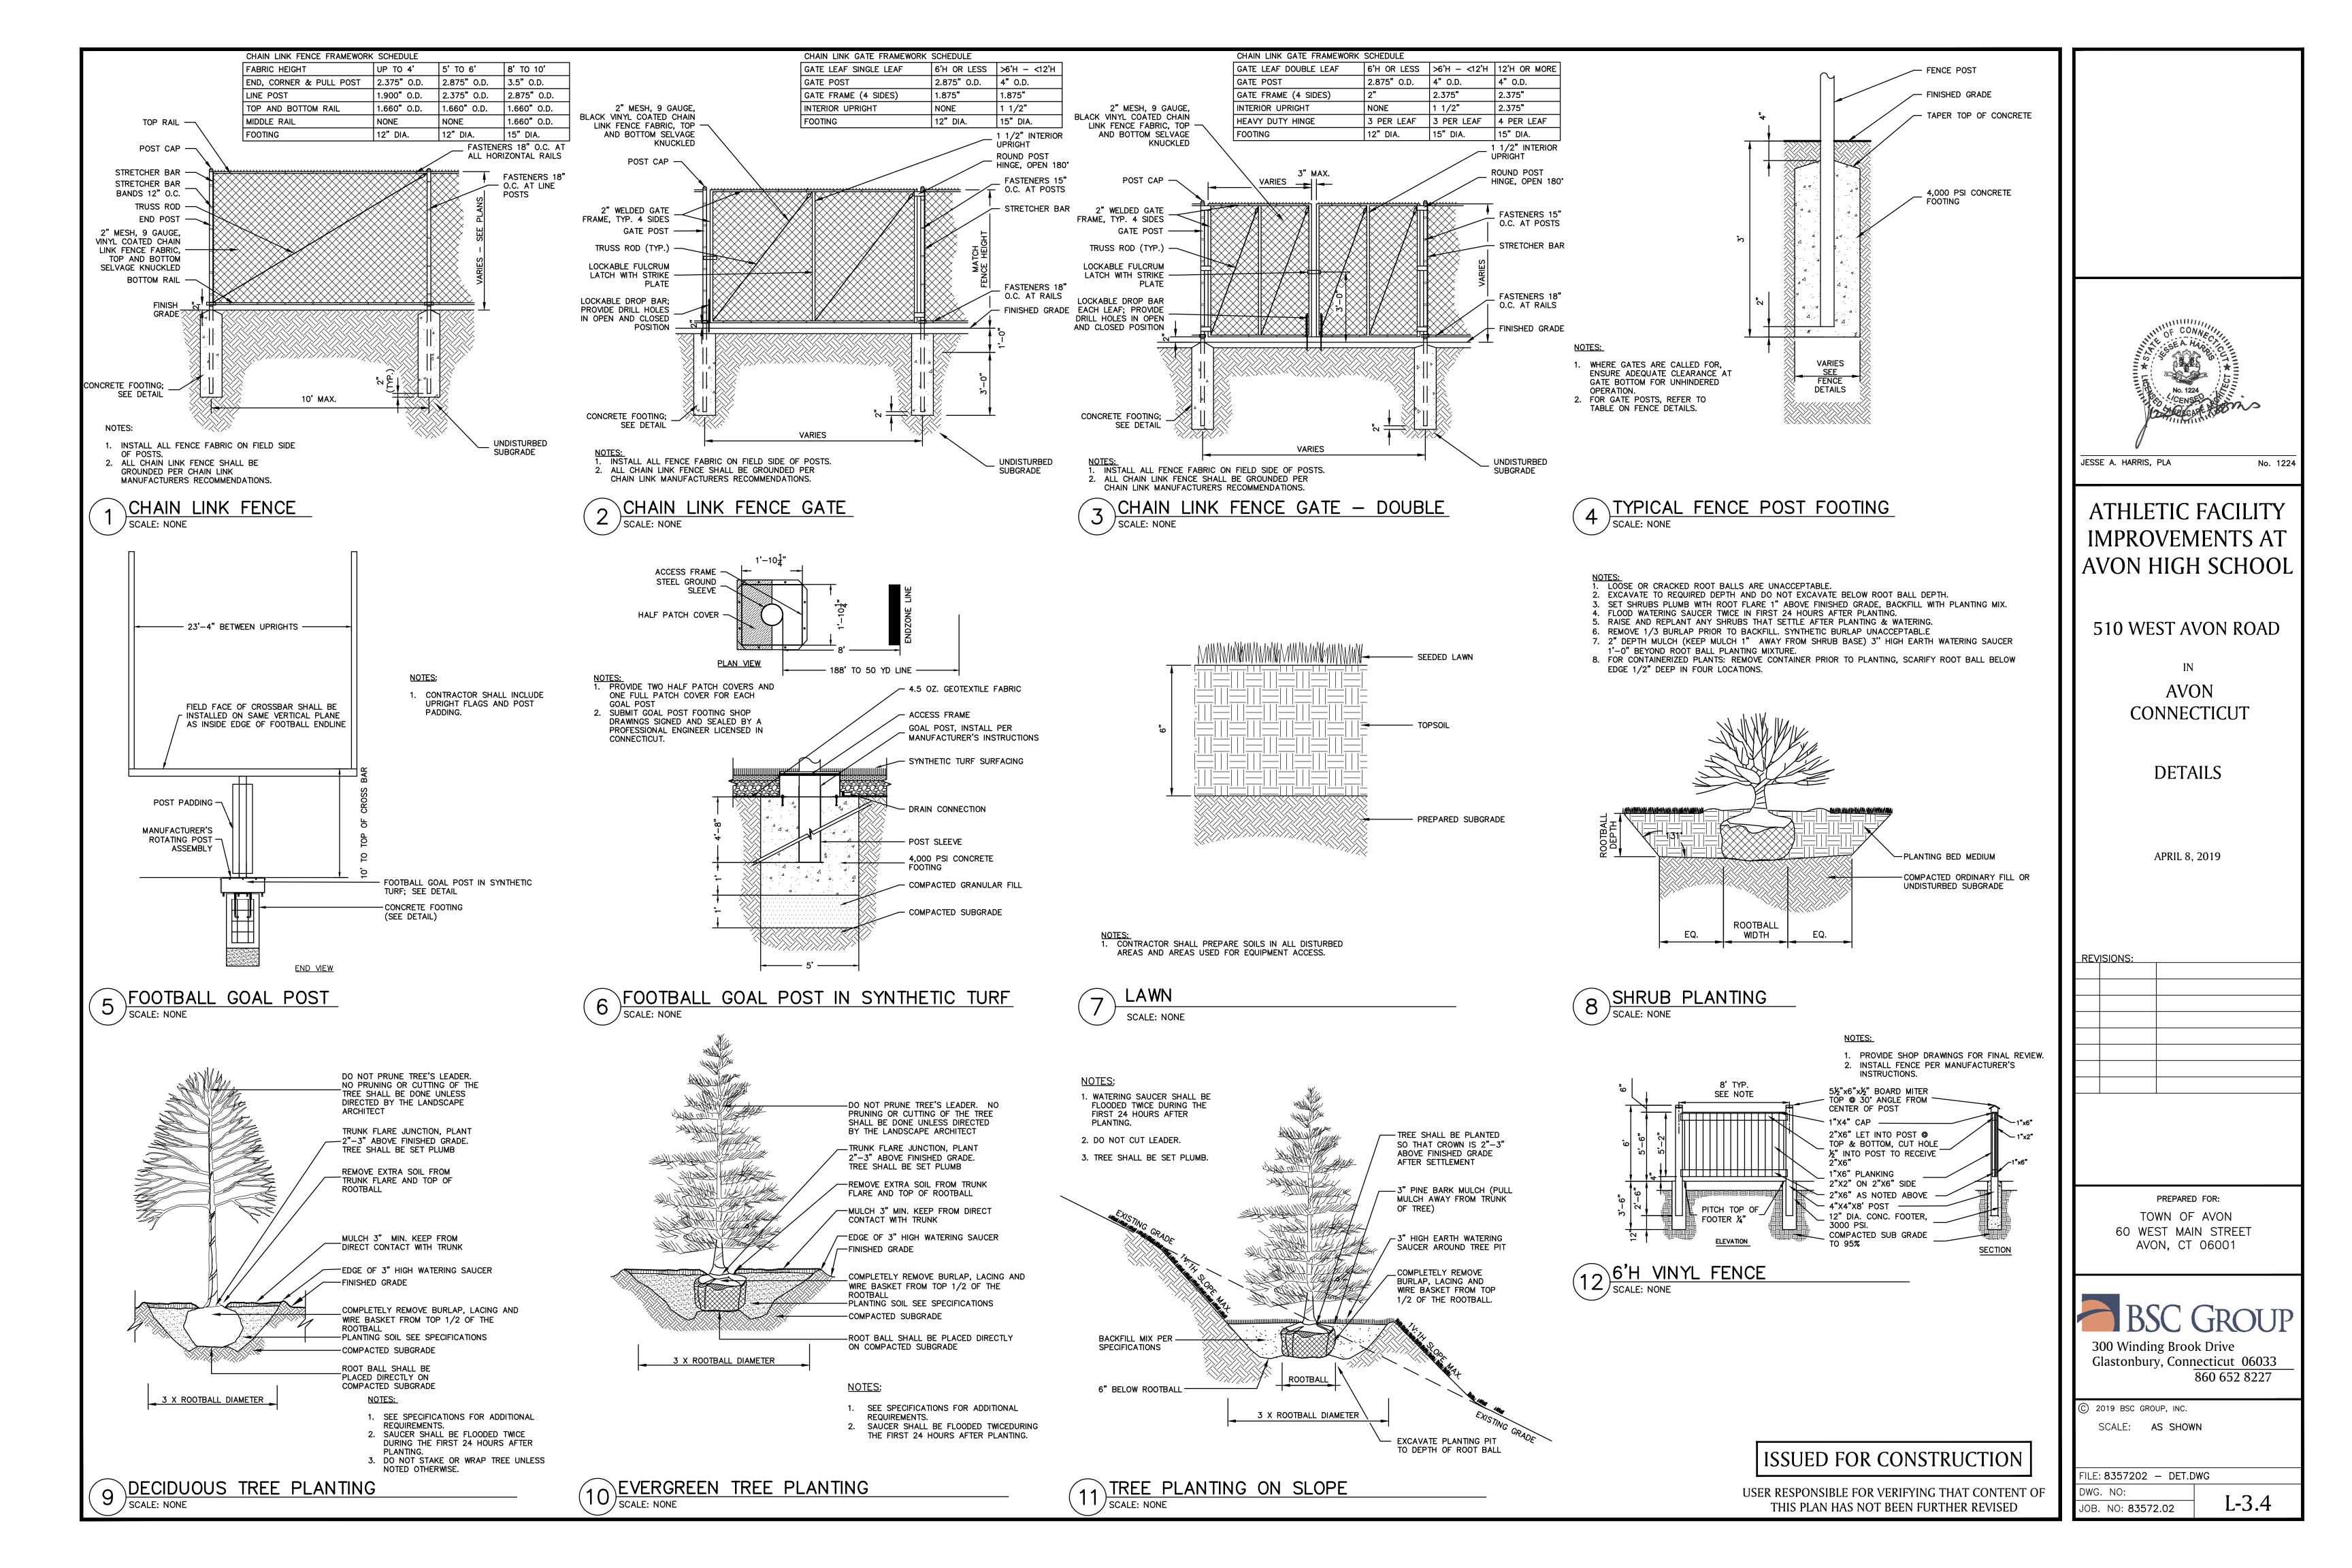

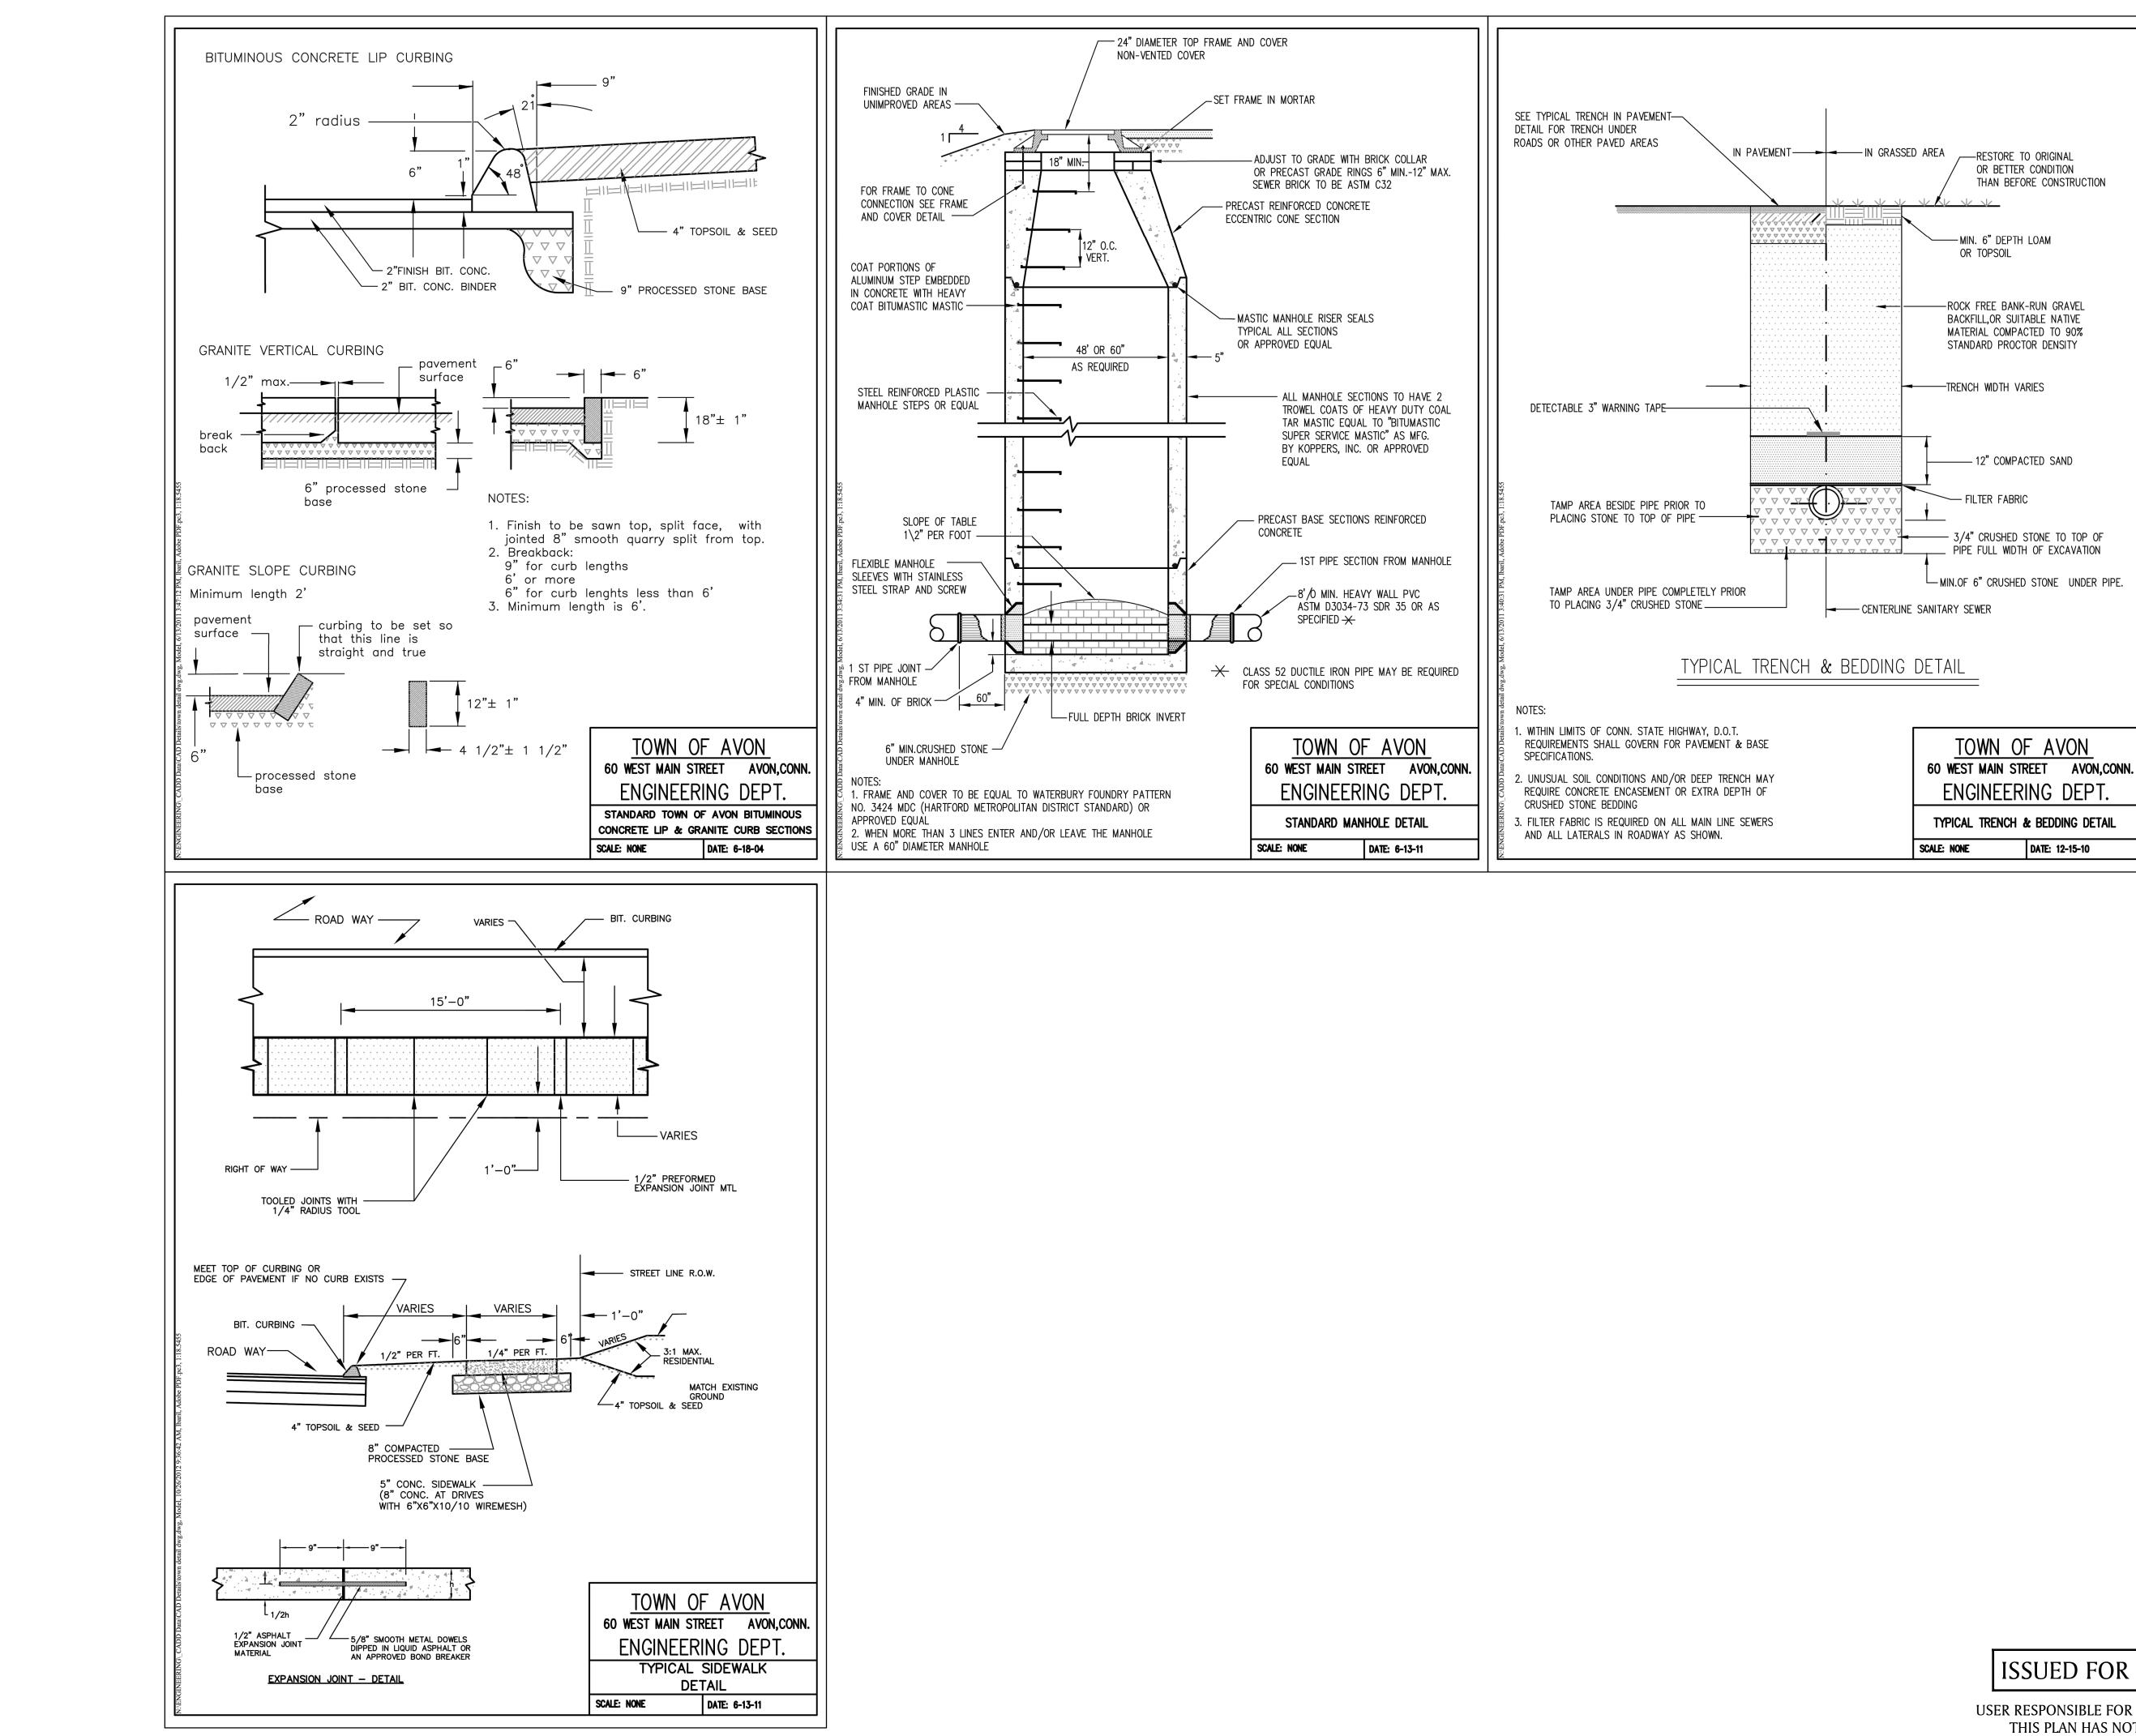



TOWN	OF A'	VON			
60 WEST MAIN	STREET	AVON, CONN.			
ENGINEE	RING	DEPT.			
TYPICAL TRENCH & BEDDING DETAIL					
SCALE: NONE	DATE: 1	12-15-10			

	ATHLETIC FACILITY IMPROVEMENTS AT AVON HIGH SCHOOL
	510 WEST AVON ROAD IN AVON CONNECTICUT
	DETAILS
	APRIL 8, 2019 REVISIONS:
	PREPARED FOR: TOWN OF AVON 60 WEST MAIN STREET AVON, CT 06001
	300 Winding Brook Drive Glastonbury, Connecticut 06033 860 652 8227
OF	© 2019 BSC GROUP, INC. SCALE: AS SHOWN FILE: 8357202 - DET.DWG DWG. NO: JOB. NO: 83572.02 L-3.5

ISSUED FOR CONSTRUCTION

USER RESPONSIBLE FOR VERIFYING THAT CONTENT THIS PLAN HAS NOT BEEN FURTHER REVISED

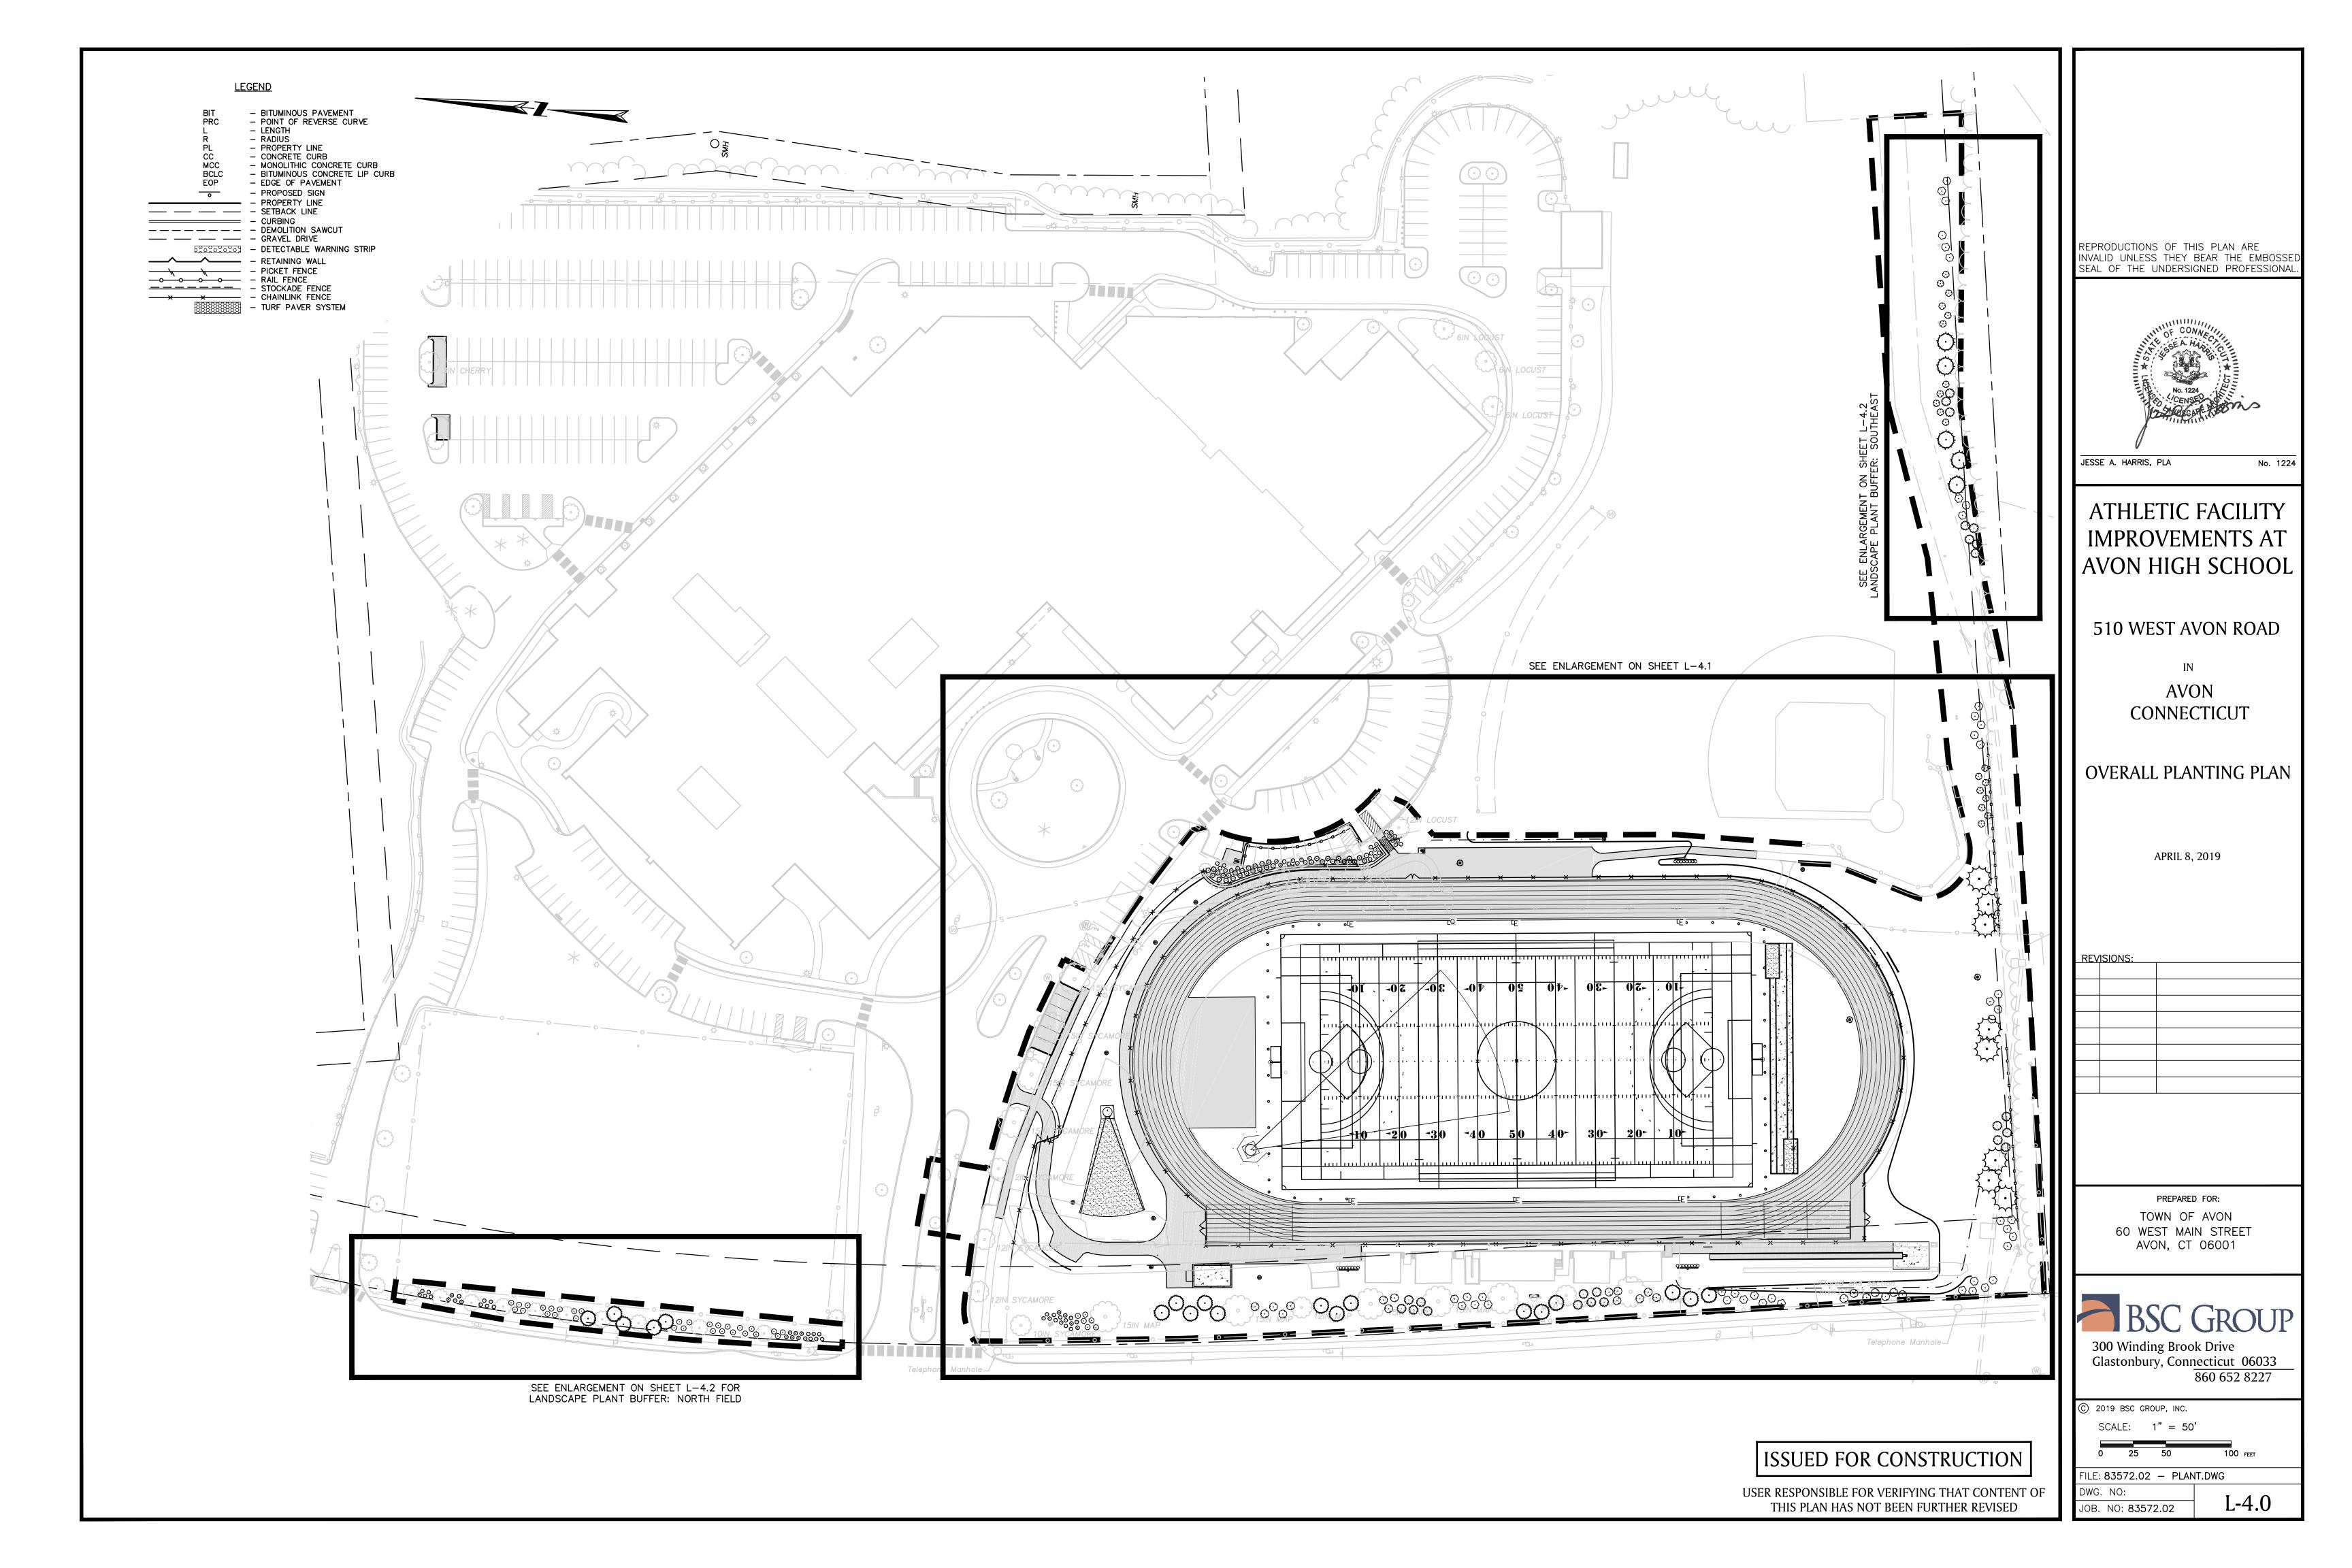

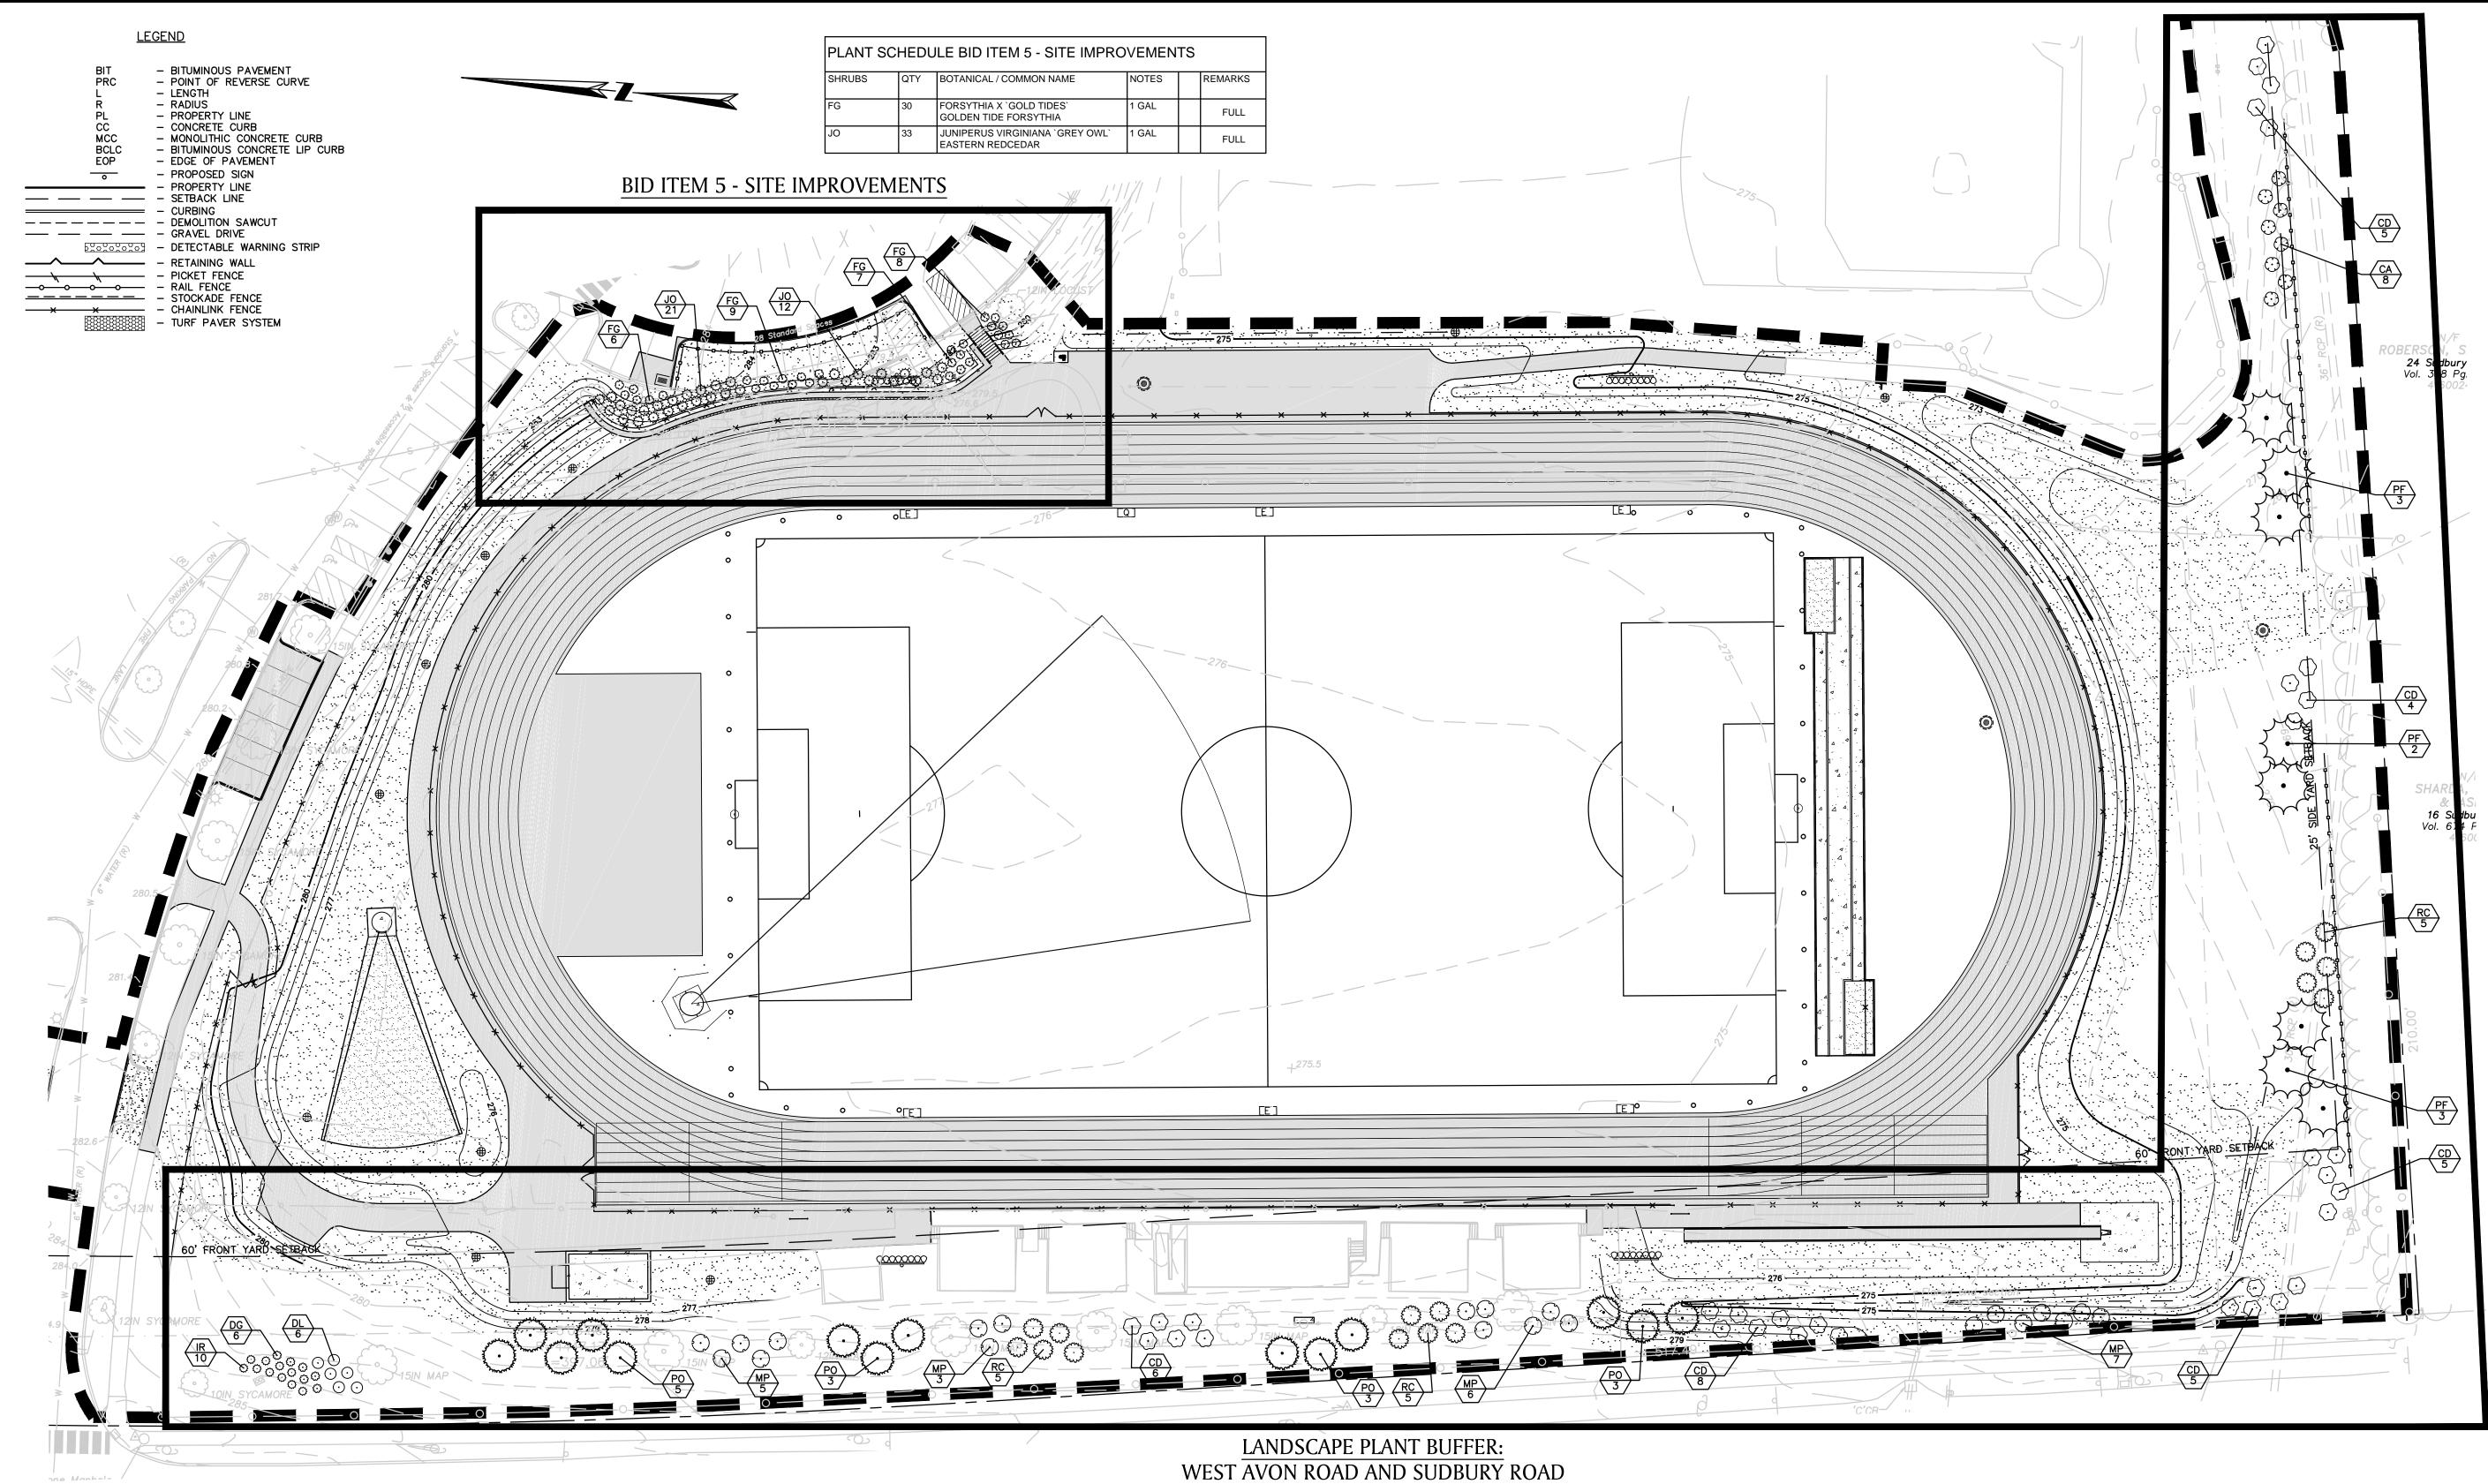

PLANT S	CHEDUL	E LANDSCAPE PLANT BUFFER: W	EST AVON	N ROAD/SUD	BURY WAY
TREES	QTY	BOTANICAL / COMMON NAME	NOTES	SIZE	REMARKS
PO	14	PICEA OMORIKA SERBIAN SPRUCE	B & B	6-7` HT	SEMI-SHEARED
PF	8	PINUS FLEXILIS `VANDERWOLF`S PYRAMID` VANDERWOLF`S PYRAMID PINE	B & B	6-7` HT	SEMI-SHEARED
SHRUBS	QTY	BOTANICAL / COMMON NAME	NOTES	SIZE	REMARKS
СА	8	CLETHRA ALNIFOLIA SUMMERSWEET CLETHRA	2 GAL	2-2.5` HT	FULL
CD	33	CORNUS ALBA TATARIAN DOGWOOD	3 GAL	3-4` HT	FULL
DG	6	DEUTZIA GRACILIS SLENDER DEUTZIA	2 GAL	18"-24"	FULL
DL	6	DIERVILLA LONICERA DWARF BUSH HONEYSUCKLE	2 GAL	2-2.5` HT	FULL
IR	10	ILEX VERTICILLATA `RED SPRITE` RED SPRITE WINTERBERRY	2 GAL	2-2.5` HT	FULL
MP	21	MYRICA PENSYLVANICA NORTHERN BAYBERRY	3 GAL	3-4` HT	FULL
RC	15	RHODODENDRON CATAWBIENSE CATAWBA RHODODENDRON	3 GAL	3-4` HT	FULL

NOTES:

- 1. ALL PLANT MATERIAL SHALL CONFORM TO THE MINIMUM GUIDELINES ESTABLISHED BY THE AMERICAN STANDARD FOR NURSERY STOCK PUBLISHED BY THE AMERICAN ASSOCIATION OF NURSERYMEN, INC.
- 2. ANY PROPOSED SUBSTITUTIONS OF PLANT MATERIAL SHALL BE MADE WITH MATERIAL EQUIVALENT TO THE DESIRED MATERIAL IN OVERALL FORM, HEIGHT, BRANCHING HABIT, FLOWER, LEAF, COLOR, FRUIT AND CULTURE. PROPOSED SUBSTITUTIONS WILL ONLY BE CONSIDERED IF SUBMITTED WITH ENUMERATED REASONS WHY SUBSTITUTIONS ARE PROPOSED. NO SUBSTITUTION OF PLANT SPECIES OR VARIETIES WILL BE ACCEPTABLE WITHOUT LANDSCAPE ARCHITECT'S WRITTEN APPROVAL.
- 3. NO PLANTING SHALL OCCUR PRIOR TO FINAL ACCEPTANCE OF GRADES.
- 4. INSTALL PLANTS WITH ROOT FLARES FLUSH WITH GRADE. IMMEDIATELY REPLANT PLANTS WHICH SETTLE OUT OF PLUMB OR BELOW FINISH GRADE.
- 5. ALL CLEARING AND SELECTIVE PRUNING AND THINNING SHALL BE PERFORMED BY A LICENSED ARBORIST.
- 6. ALL TREES TO BE SAVED SHALL BE PROTECTED PER SPECIFICATION.
- 7. THE LANDSCAPE ARCHITECT OR ENGINEER RESERVES THE RIGHT TO ADJUST FINAL GRADES IN THE FIELD TO SAVE EXISTING VEGETATION.
- 8. PLANT QUANTITIES NOTED IN THE PLANT SCHEDULE ARE APPROXIMATE AND ARE PROVIDED FOR THE CONVENIENCE OF THE CONTRACTOR. THE CONTRACTOR SHALL BE RESPONSIBLE FOR THE FURNISHING AND INSTALLATION OF ALL PLANT MATERIALS NOTED ON THE PLANTING PLAN.
- 9. PROVIDE FIVE (5) FOOT DIAMETER MULCH CIRCLE AROUND ALL INDIVIDUAL TREE PLANTINGS AND CONTINUOUS MULCH BED AROUND SHRUB, PERENNIAL AND GROUNDCOVER PLANTINGS.
- 10. PLANT UNDER FULL SUPERVISION OF CERTIFIED ARBORIST, NURSERYMAN, OR LICENSED LANDSCAPE ARCHITECT. PROVIDE WRITTEN VERIFICATION OF CERTIFICATION AND/OR LICENSE FOR OWNER'S REPRESENTATIVE'S APPROVAL.

11. COMPLETE QUANTITIES OF PLANTS FOR EACH AREA TO BE AVAILABLE ON SITE AT THE TIME OF PLANTING FOR FIELD LAYOUT BY OWNER'S REPRESENTATIVE. NO PARTIAL LAYOUT AND PLANTING OF AREAS WILL BE ACCEPTABLE.

12. LOOSE OR CRACKED ROOTBALLS ARE UNACCEPTABLE.

13. WATER PLANTS THOROUGHLY AFTER INSTALLATION, A MINIMUM OF TWICE WITHIN THE FIRST 24 HOURS. 14. PLANTS WITHIN CRITICAL ROOT ZONE OF EXISTING TREES MUST BE HAND DUG. CRITICAL ROOT ZONE = DBH (IN INCHES) X 1.5.

REPRODUCTIONS OF THIS PLAN ARE INVALID UNLESS THEY BEAR THE EMBOSSED SEAL OF THE UNDERSIGNED PROFESSIONAL.
No. 1224
JESSE A. HARRIS, PLA No. 1224
ATHLETIC FACILITY IMPROVEMENTS AT AVON HIGH SCHOOL
510 WEST AVON ROAD
IN AVON CONNECTICUT
PLANTING PLAN ENLARGMENTS
APRIL 8, 2019
_ REVISIONS:
prepared for: TOWN OF AVON 60 WEST MAIN STREET AVON, CT 06001
BSC GROUP 300 Winding Brook Drive Glastonbury, Connecticut 06033 860 652 8227
© 2019 BSC GROUP, INC. SCALE: $1'' = 30'$ 0 15 30 60 FEET

FILE: 83572.02 - PLANT.DWG

L-4.1


DWG. NO:

JOB. NO: 83572.02

USER RESPONSIBLE FOR VERIFYING THAT CONTENT OF THIS PLAN HAS NOT BEEN FURTHER REVISED

ISSUED FOR CONSTRUCTION



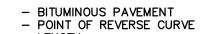

- LENGTH – RADIUS - PROPERTY LINE
- CONCRETE CURB
 MONOLITHIC CONCRETE CURB
- BITUMINOUS CONCRETE LIP CURB – EDGE OF PAVEMENT
- PROPOSED SIGN - PROPERTY LINE
- ----- --- --- SETBACK LINE - CURBING ----- --- --- --- GRAVEL DRIVE — — RETAINING WALL

BIT


PL

CC MCC BCLC

EOP

PRC

- boossing
 DETECTABLE
 WARNING
 STRIP
- ——————— STOCKADE FENCE — × × – CHAINLINK FENCE TURF PAVER SYSTEM

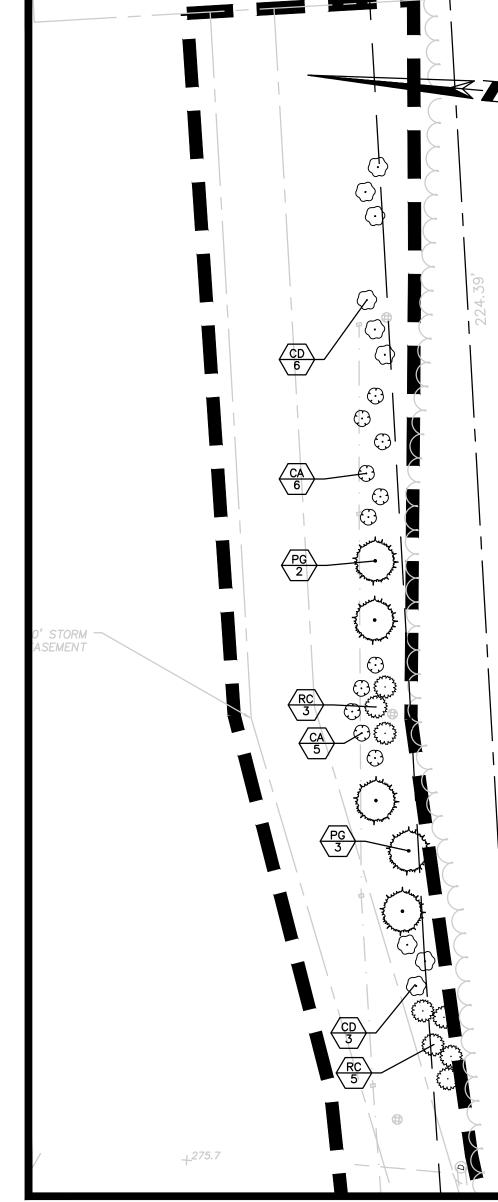


CARLSON, & 10 **28 Sudbury** Vol. 647 Pg.

41600

LANDSCAPE PLANT BUFFER: SOUTHEAST

TREES		JLE LANDSCAPE PLANT E		SIZE	REMARKS
PG	5	PICEA GLAUCA WHITE SPRUCE	B & B	6-7` HT	SEMI- SHEARED
SHRUBS	QTY	BOTANICAL / COMMON NAME	NOTES	SIZE	REMARKS
CA	11	CLETHRA ALNIFOLIA SUMMERSWEET CLETHRA	2 GAL	2-2.5` HT	FULL
CD	9	CORNUS ALBA TATARIAN DOGWOOD	3 GAL	3-4` HT	FULL
RC	8	RHODODENDRON CATAWBIENSE CATAWBA RHODODENDRON	3 GAL	3-4` HT	FULL

LANDSCAPE PLANT BUFFER: NORTH FIELD

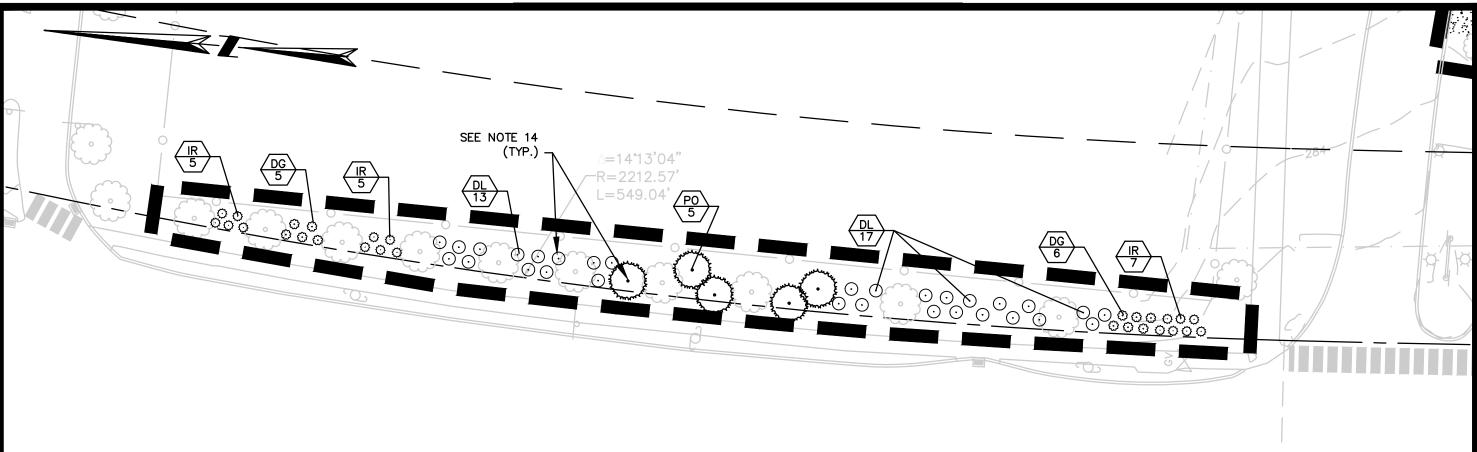

<u>NOTES:</u>

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- DBH (IN INCHES) X 1.5.



PLANT S	SCHED	JLE LANDSCAPE PLANT E	BUFFER	: NORTH	FIELD
TREES	QTY	BOTANICAL / COMMON NAME	NOTES	SIZE	REMARKS
PO	5	PICEA OMORIKA SERBIAN SPRUCE	B & B	6-7` HT	SEMI- SHEARED
		-			
SHRUBS	QTY	BOTANICAL / COMMON NAME	NOTES	SIZE	REMARKS
DG	11	DEUTZIA GRACILIS SLENDER DEUTZIA	2 GAL	18"-24"	FULL
DL	30	DIERVILLA LONICERA DWARF BUSH HONEYSUCKLE	2 GAL	2-2.5` HT	FULL
IR	17	ILEX VERTICILLATA `RED SPRITE`	2 GAL	2-2.5` HT	FULL

RED SPRITE WINTERBERRY

REPRODUCTIONS OF THIS PLAN ARE
INVALID UNLESS THEY BEAR THE EMBOSSED SEAL OF THE UNDERSIGNED PROFESSIONAL.
OF CONNECTION
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TO STOCENSED
JESSE A. HARRIS, PLA No. 1224
ATHLETIC FACILITY
IMPROVEMENTS AT
AVON HIGH SCHOOL
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IN AVON
CONNECTICUT
PLANTING PLAN ENLARGEMENTS (CONT.)
ENLARGEMENTS (CONT.)
APRIL 8, 2019
REVISIONS:
PREPARED FOR:
TOWN OF AVON 60 WEST MAIN STREET
AVON, CT 06001
BSC GROUP
300 Winding Brook Drive Glastonbury, Connecticut 06033
860 652 8227
© 2019 BSC GROUP, INC. SCALE: 1" = 30'
0 15 30 60 FEET

JOB. NO: 83572.02


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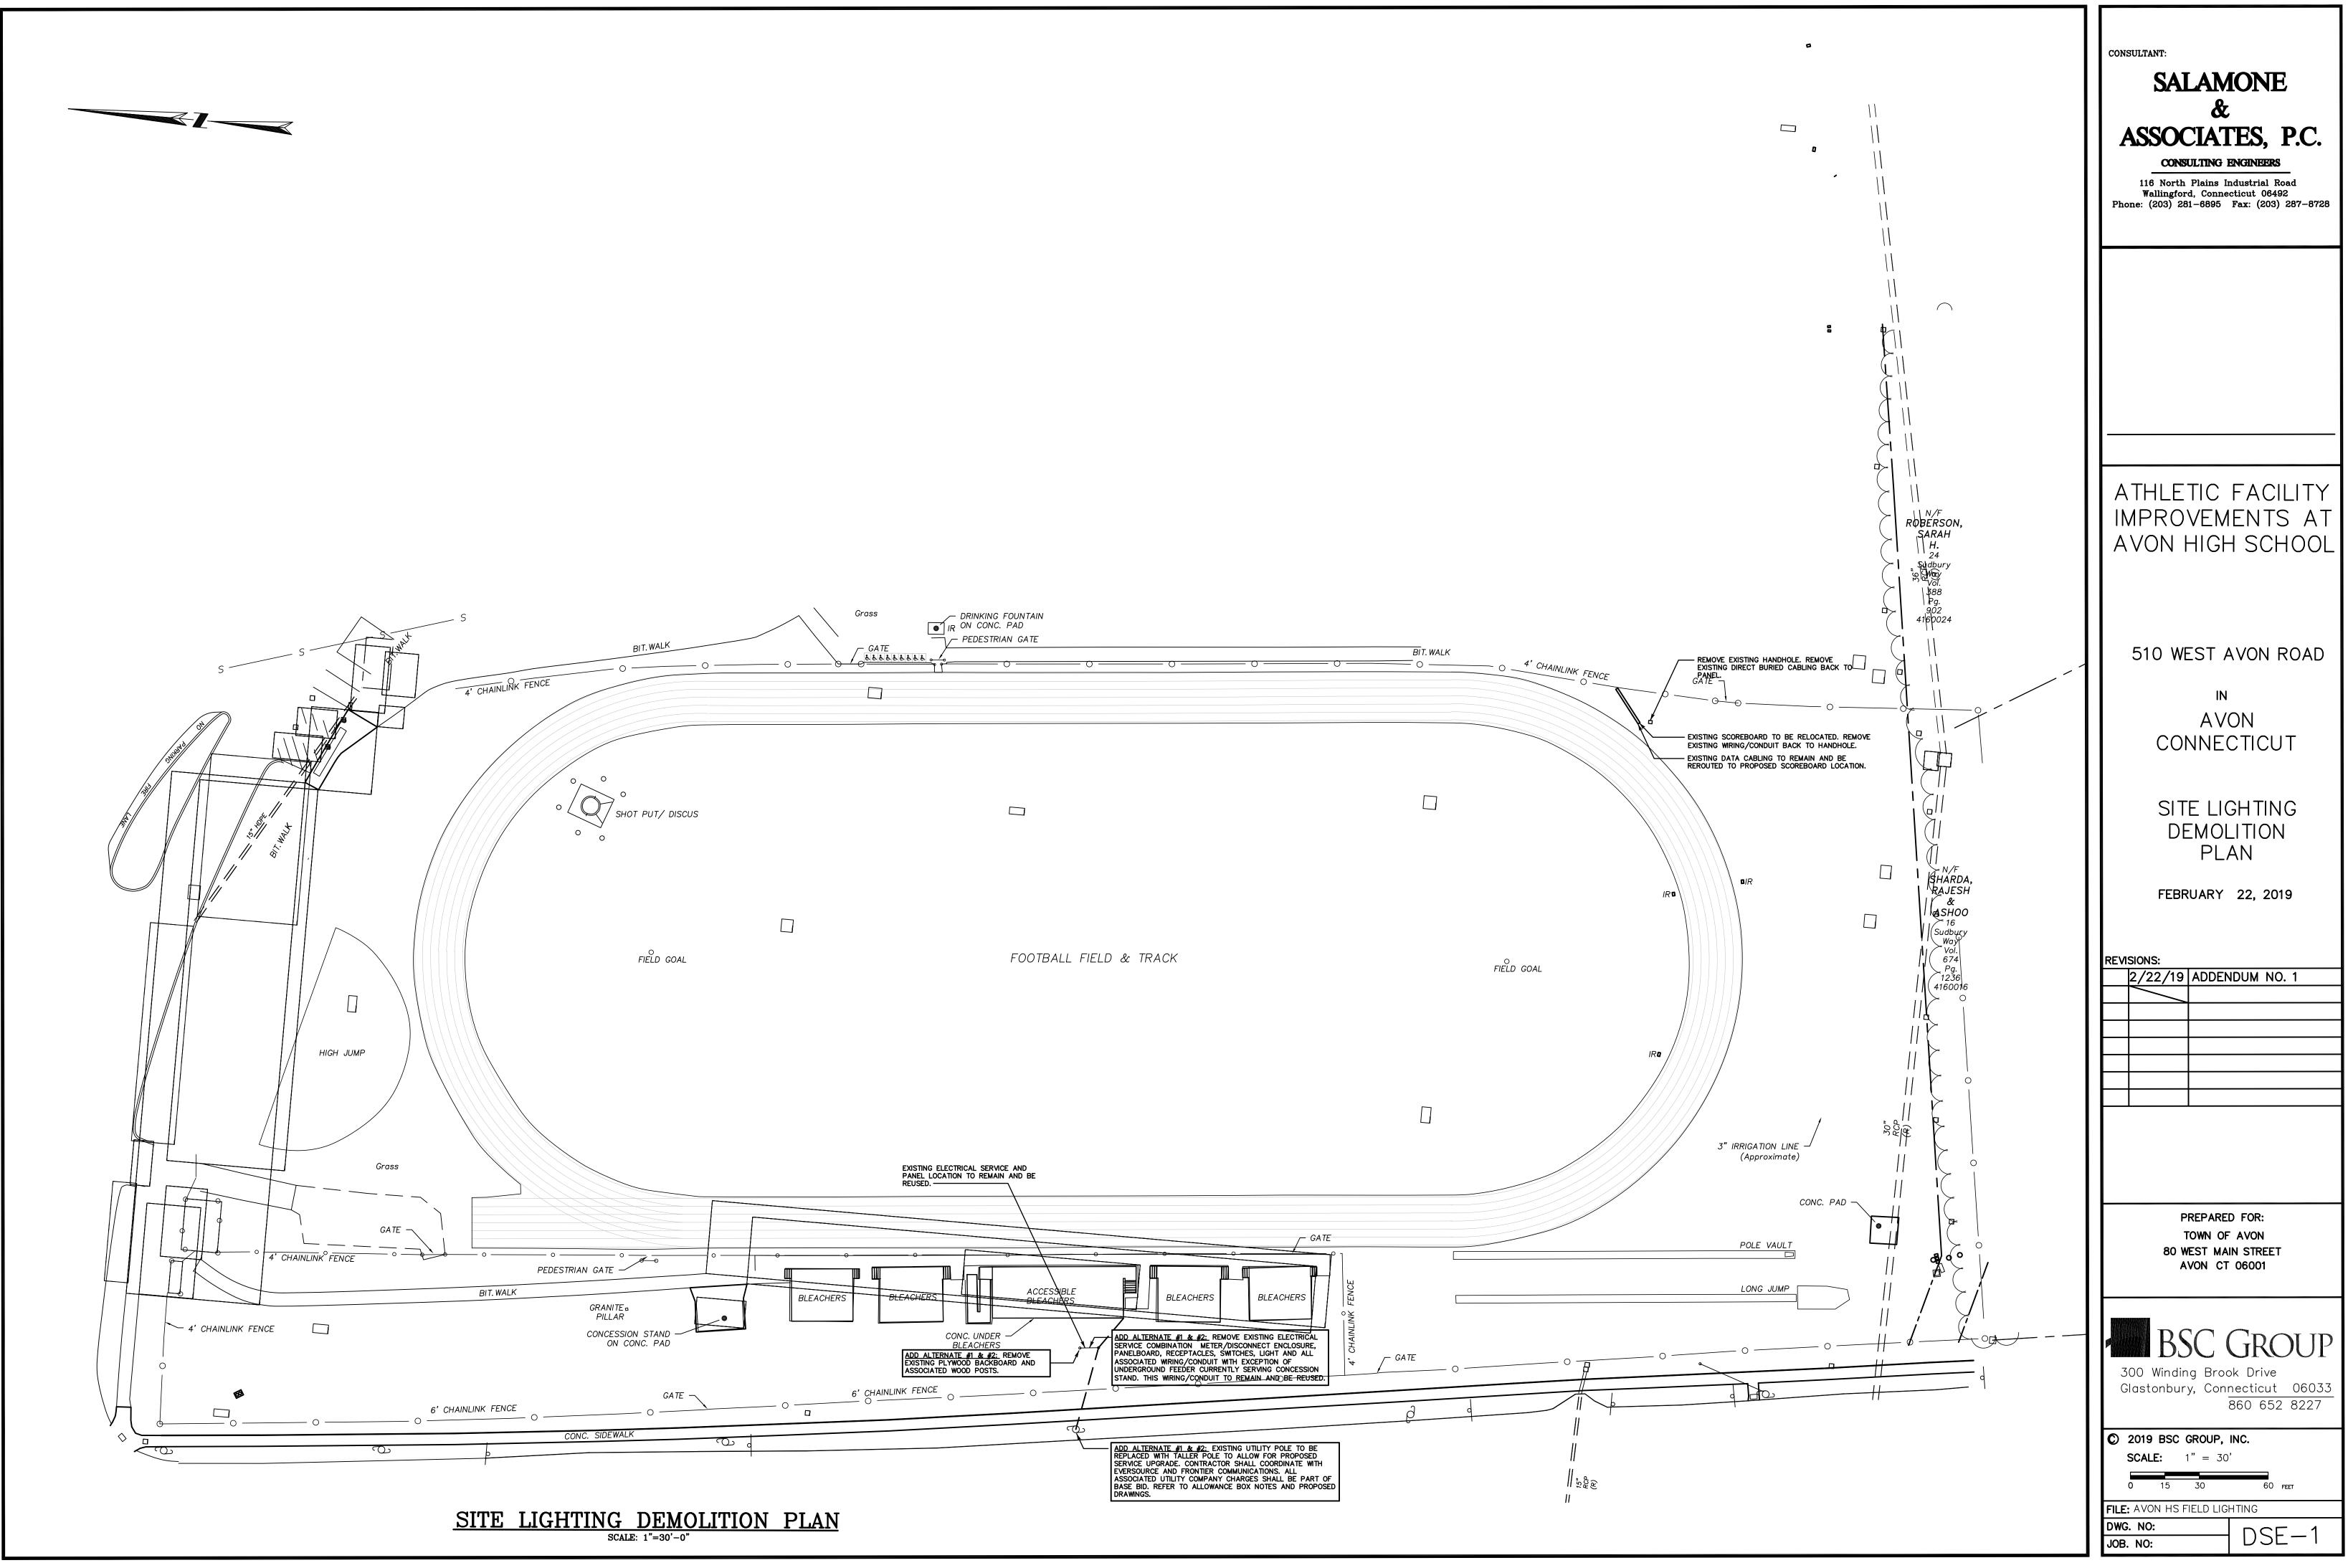
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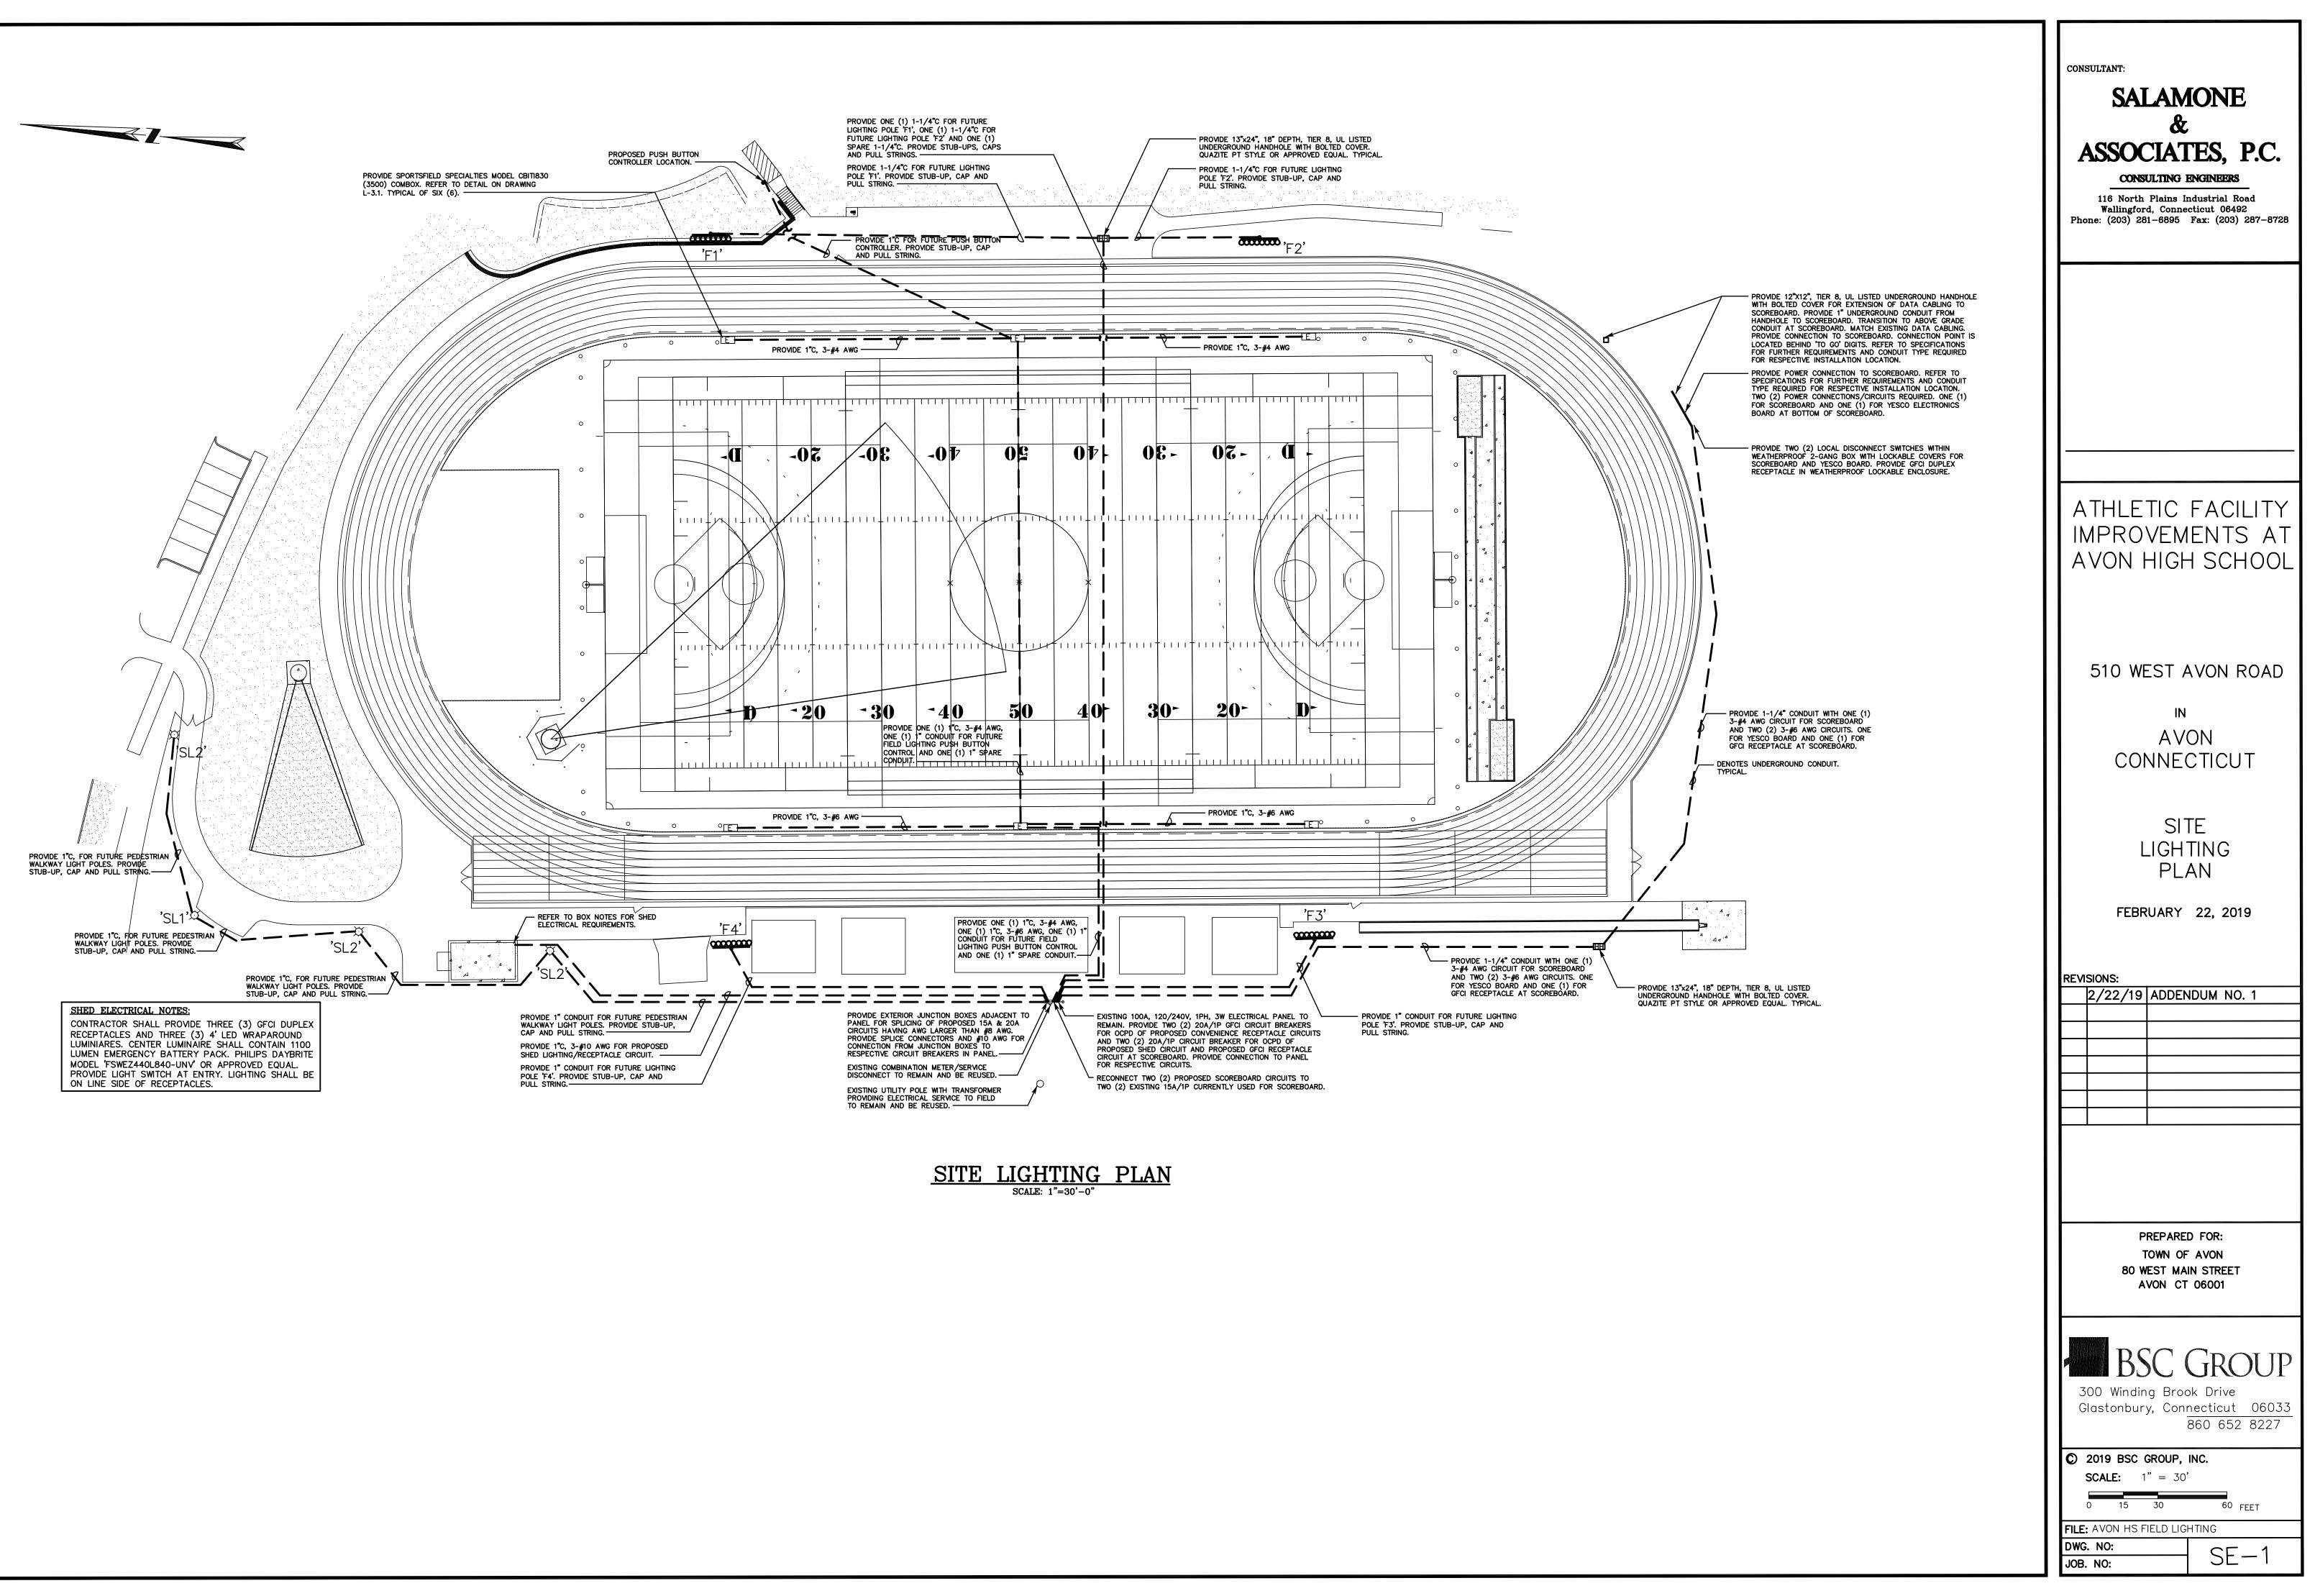
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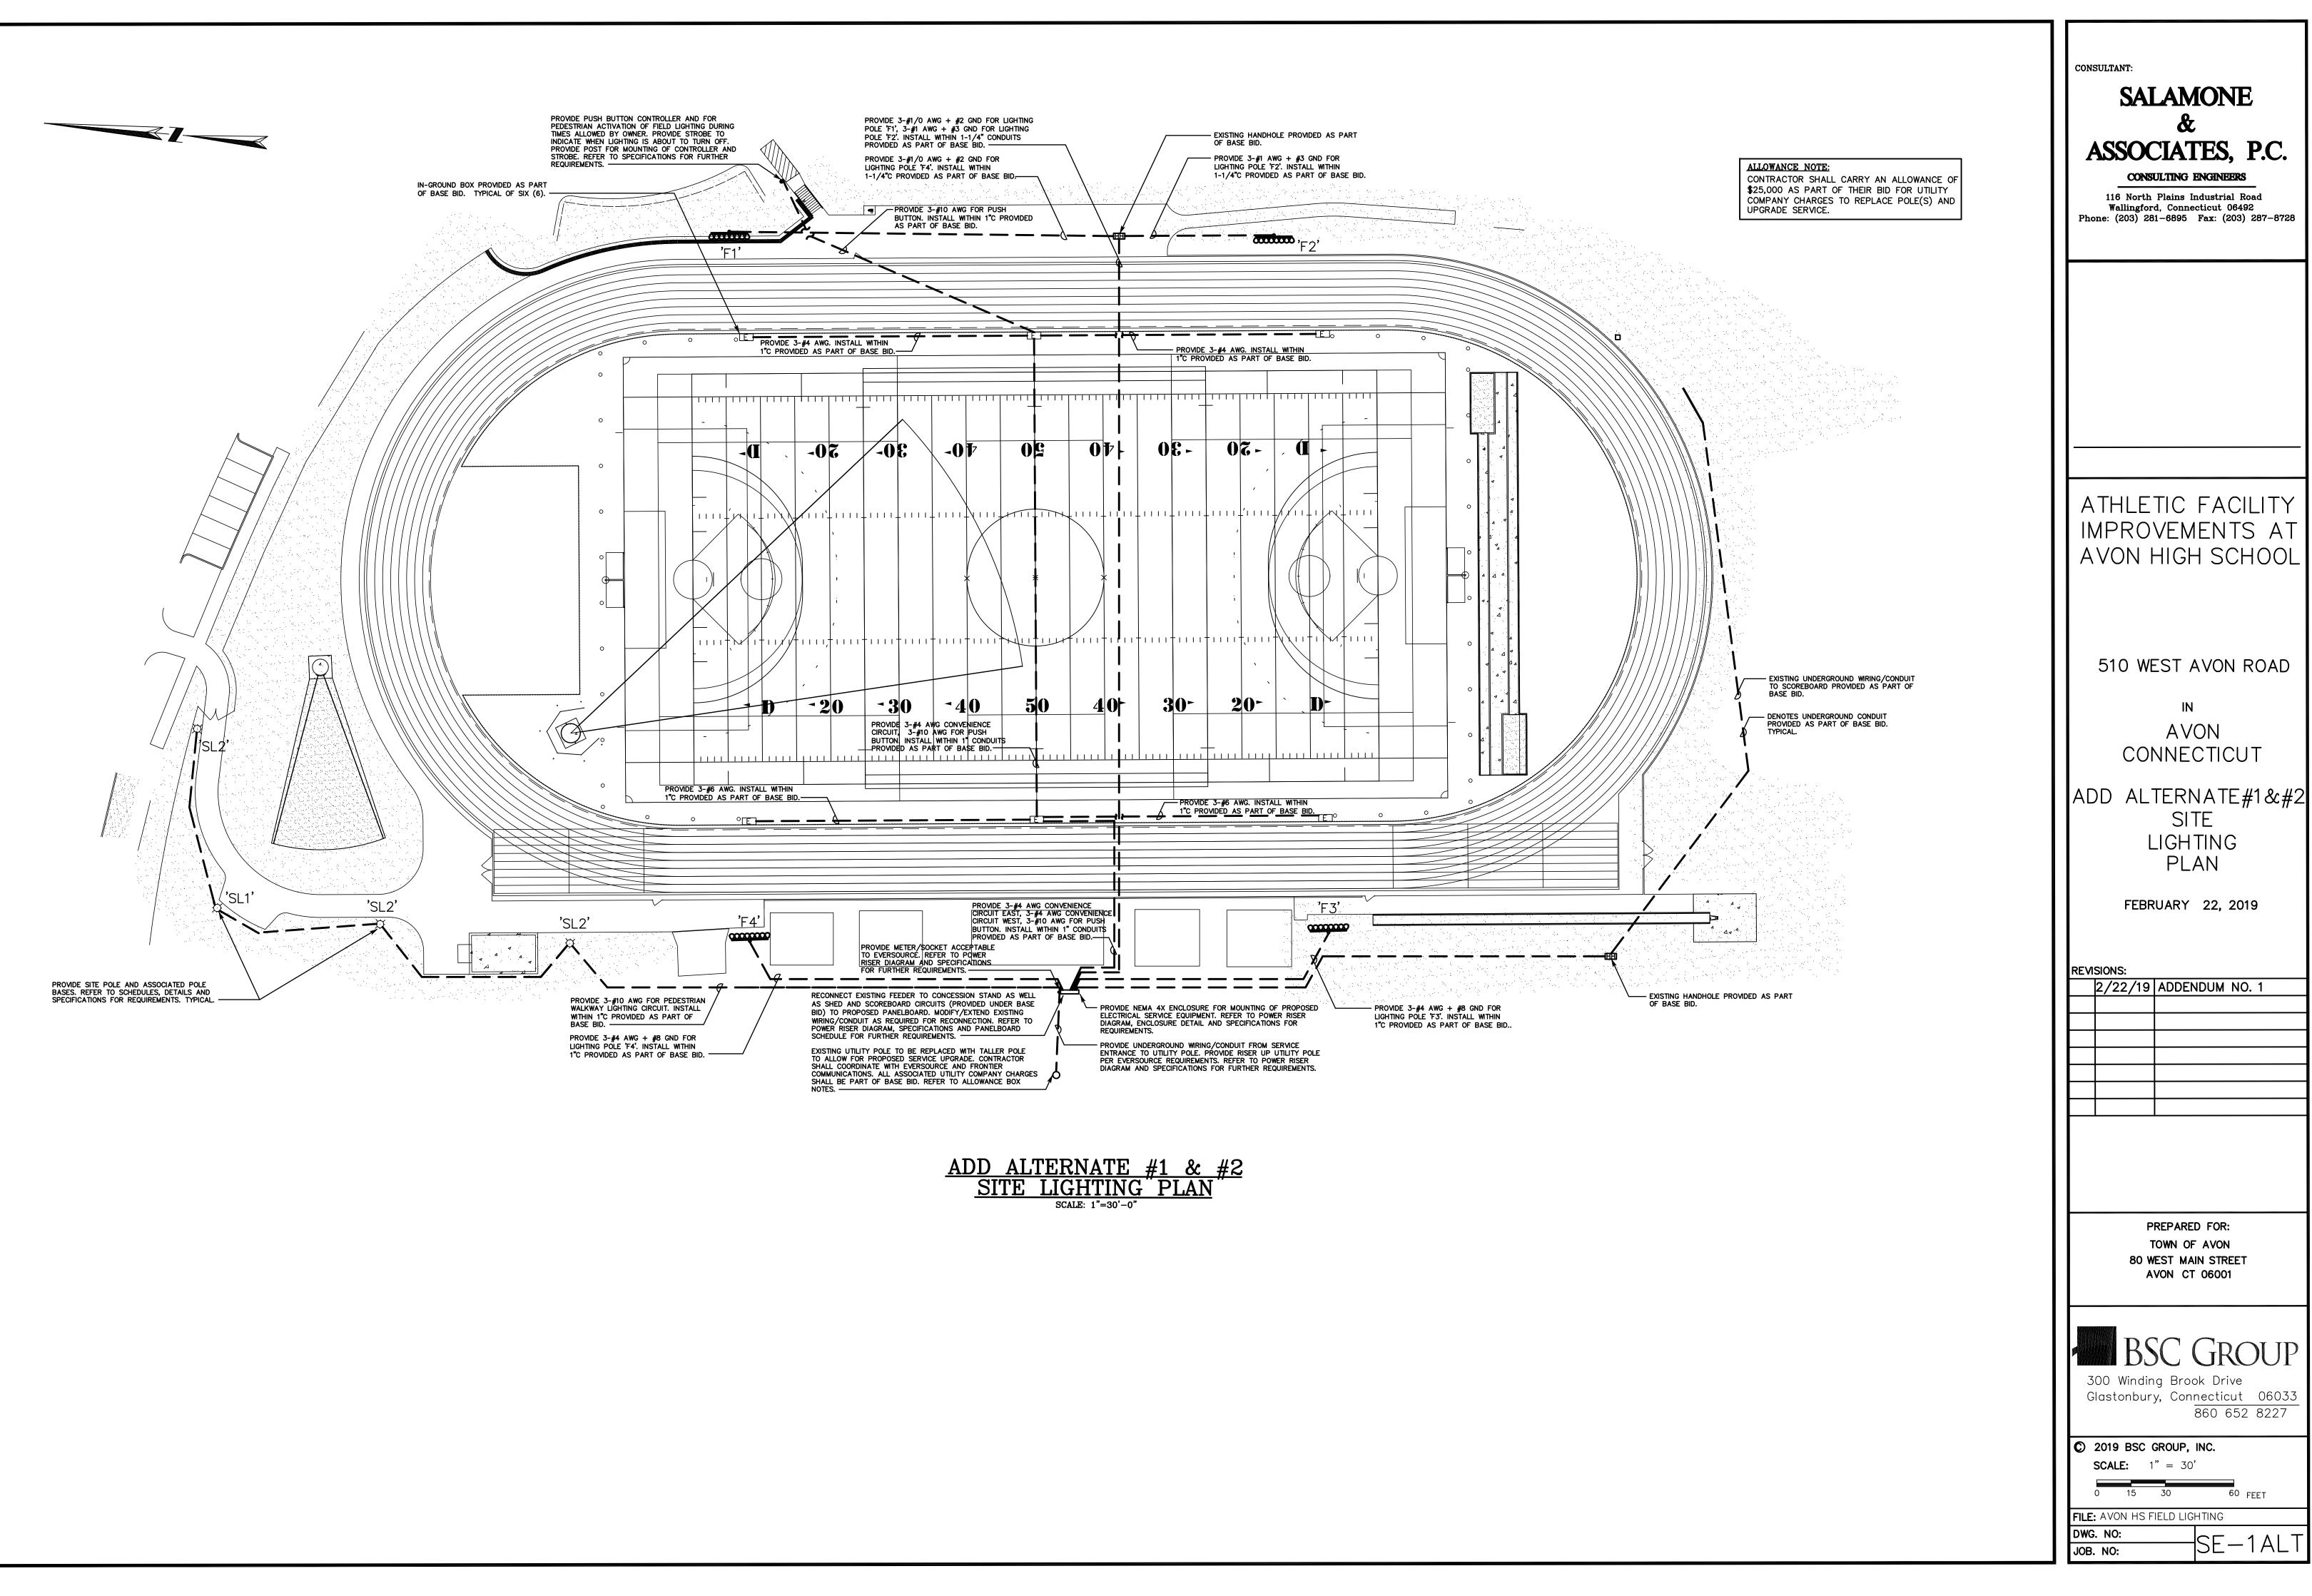
ISSUED FOR CONSTRUCTION


USER RESPONSIBLE FOR VERIFYING THAT CONTENT OF THIS PLAN HAS NOT BEEN FURTHER REVISED







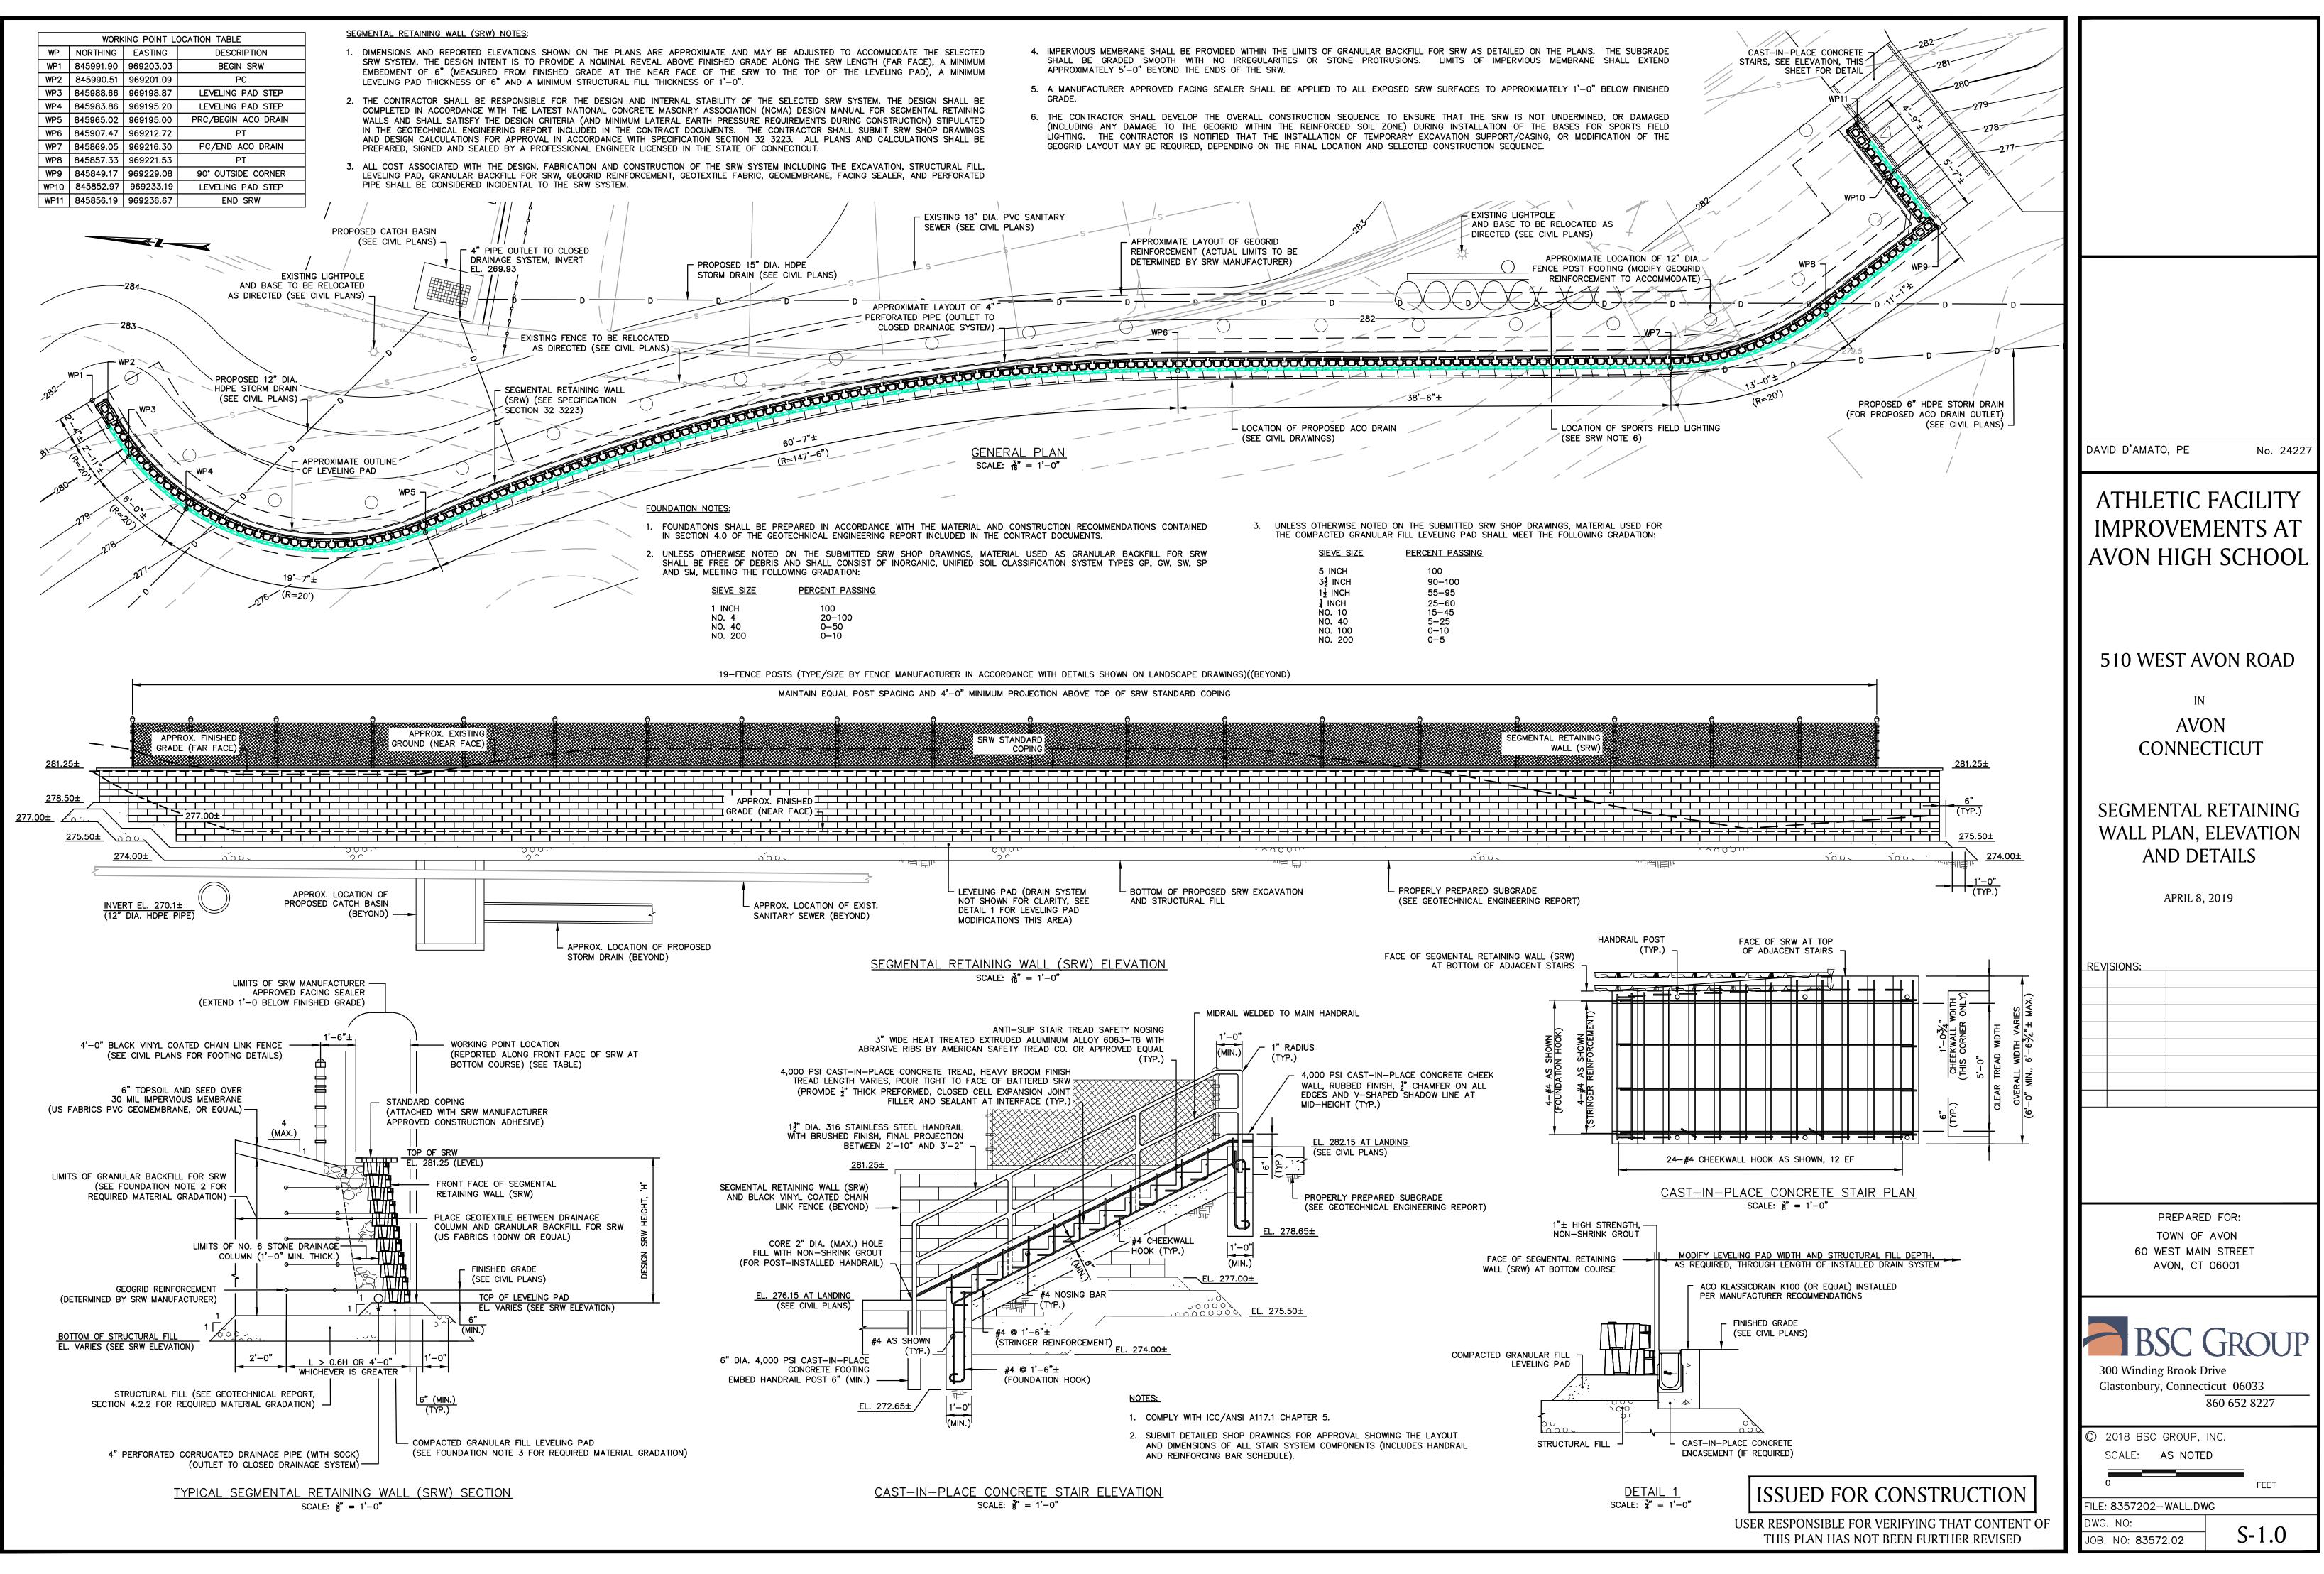

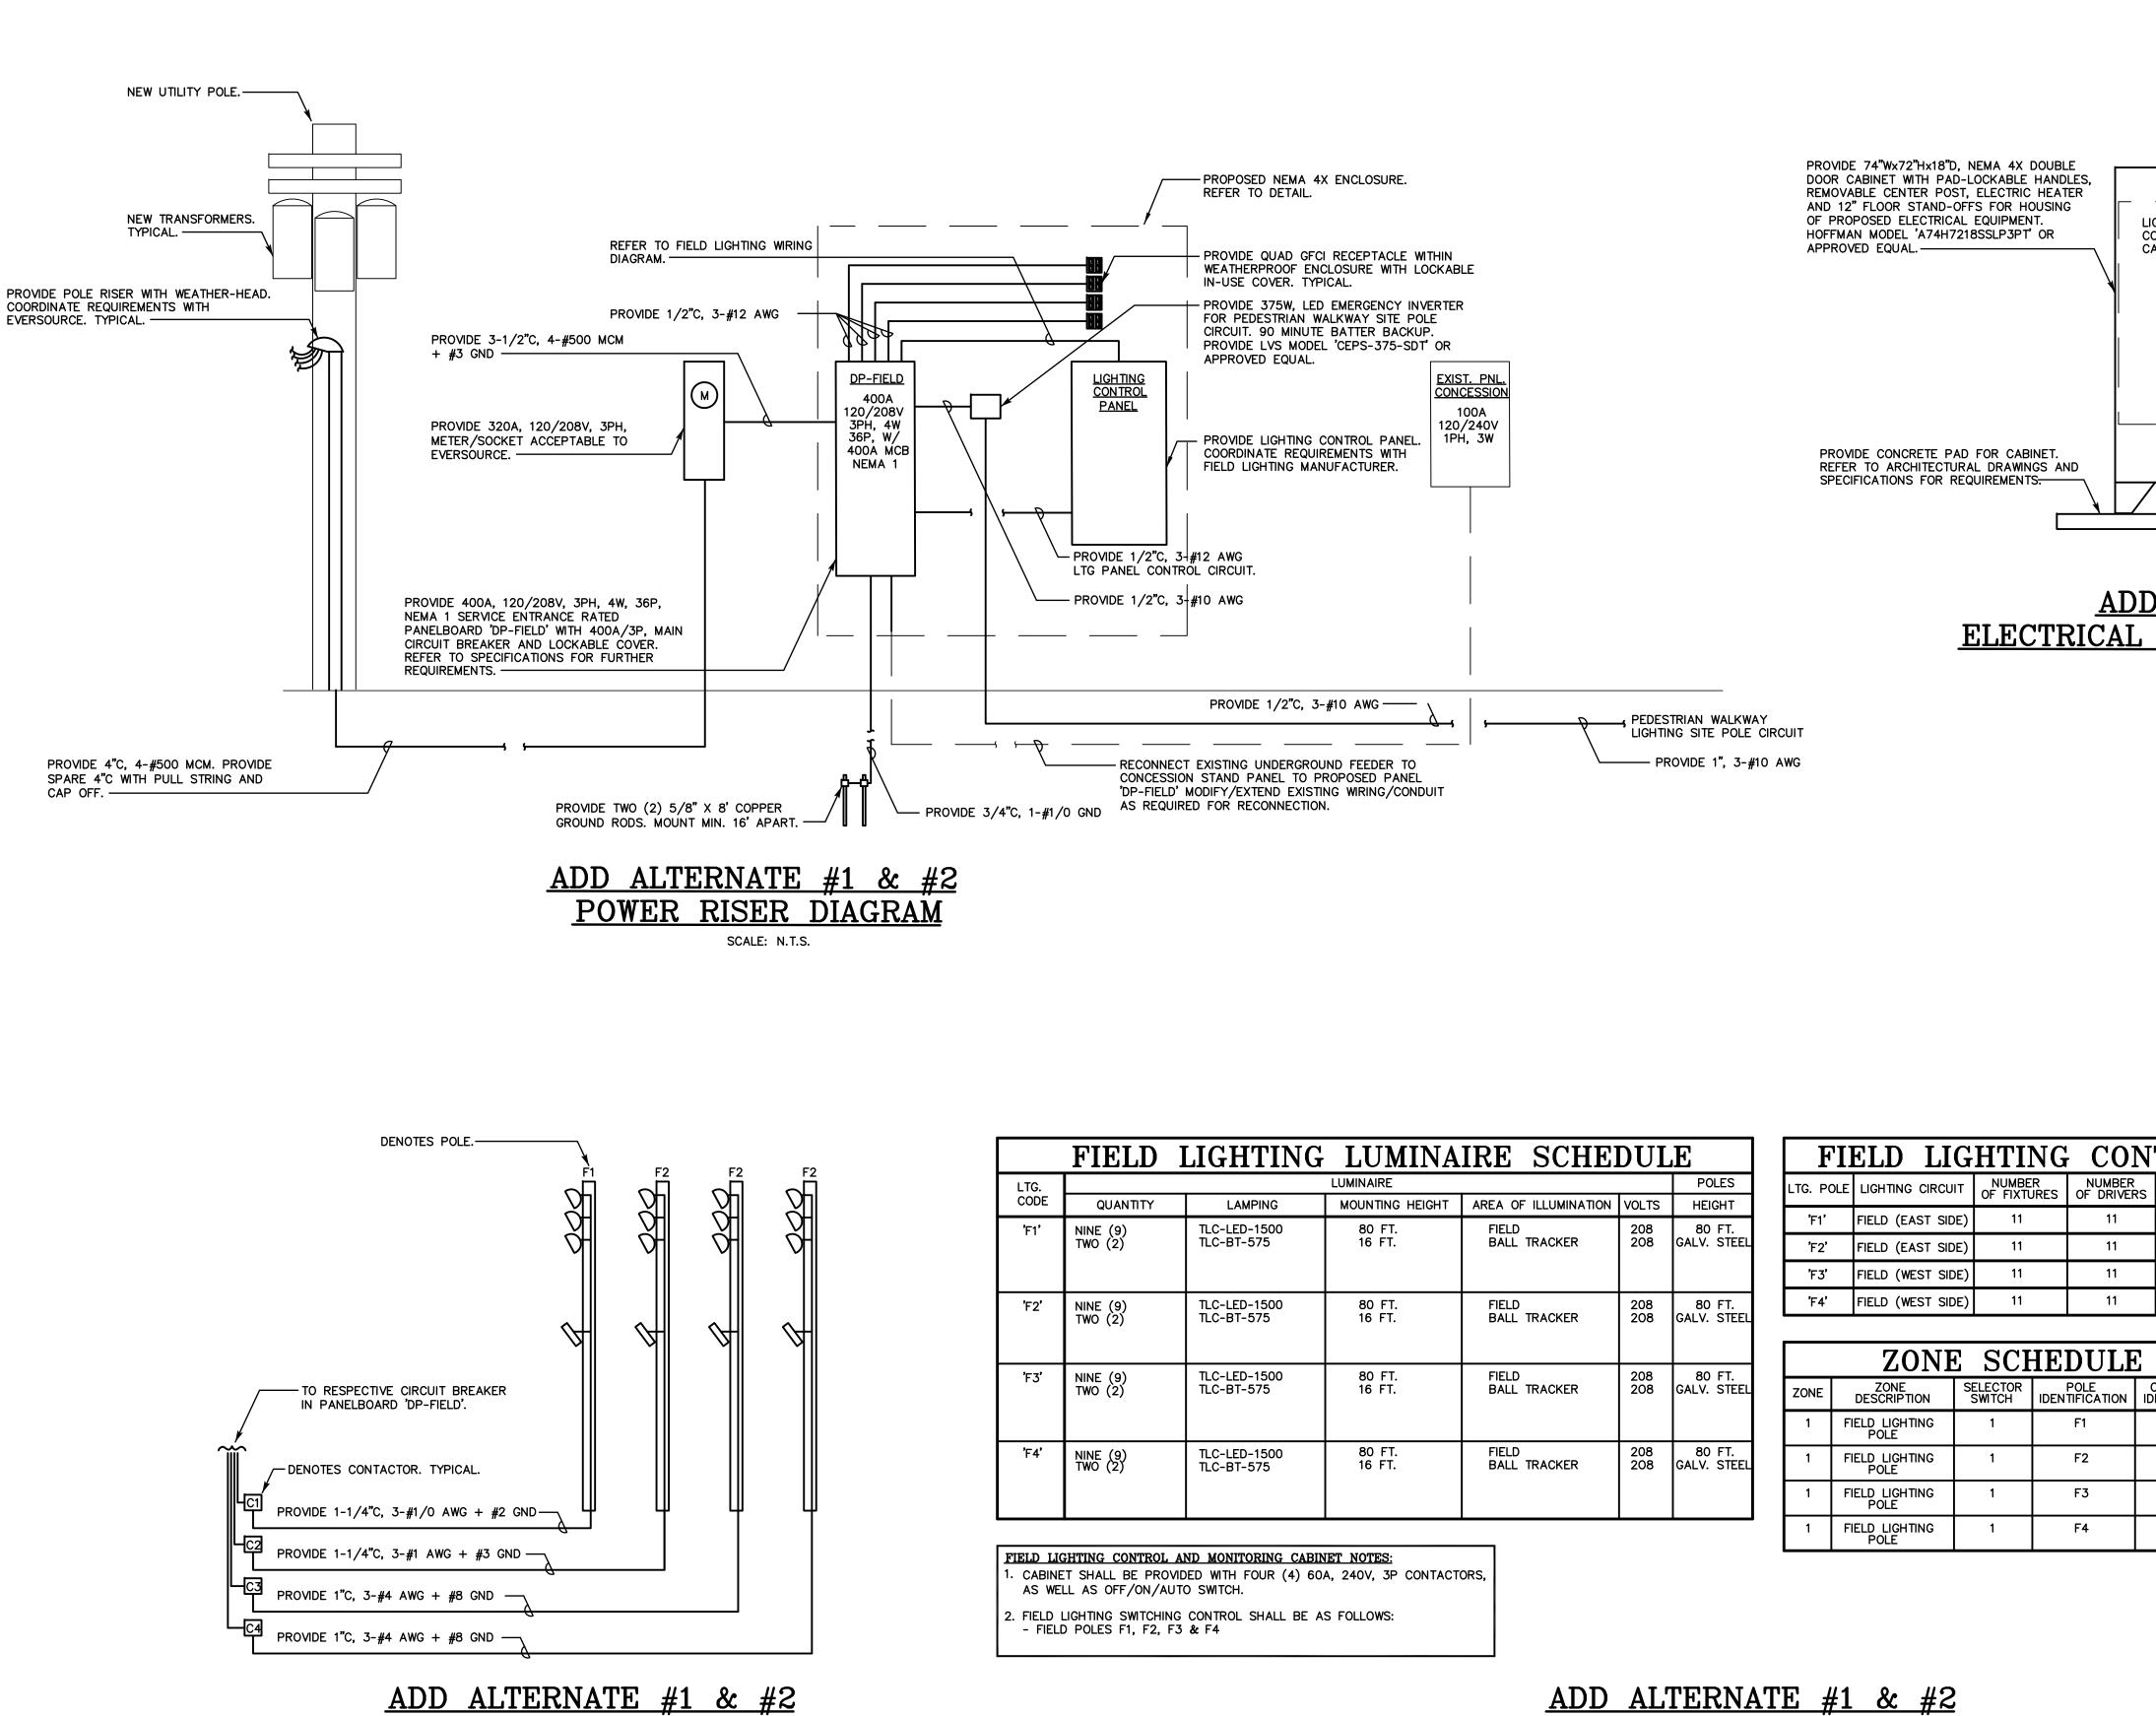

	FIELD]	LIGHTING	LUMINA	IRE SCHE	DUL	E
LTG.			LUMINAIRE			POLES
CODE	QUANTITY	LAMPING	MOUNTING HEIGHT	AREA OF ILLUMINATION	VOLTS	HEIGHT
'F1'	NINE (9)	TLC-LED-1500	80 FT.	FIELD	208	80 FT.
	TWO (2)	TLC-BT-575	16 FT.	BALL TRACKER	208	GALV. STEEL
'F2'	NINE (9)	TLC-LED-1500	80 FT.	FIELD	208	80 FT.
	TWO (2)	TLC-BT-575	16 FT.	BALL TRACKER	208	GALV. STEEL
'F3'	NINE (9)	TLC-LED-1500	80 FT.	FIELD	208	80 FT.
	TWO (2)	TLC-BT-575	16 FT.	BALL TRACKER	208	GALV. STEEL
'F4'	NINE (9)	TLC-LED-1500	80 FT.	FIELD	208	80 FT.
	TWO (2)	TLC-BT-575	16 FT.	BALL TRACKER	208	GALV. STEEL


				_
FI	ELD LIG	HTING	- CON	Ί
LTG. POLE	LIGHTING CIRCUIT	NUMBER OF FIXTURES	NUMBER OF DRIVERS	
'F1'	FIELD (EAST SIDE)	11	11	
'F2'	FIELD (EAST SIDE)	11	11	
'F3'	FIELD (WEST SIDE)	11	11	
'F4'	FIELD (WEST SIDE)	11	11	

ZONE SCHEDULE								
ZONE	ZONE DESCRIPTION	SELECTOR SWITCH	POLE IDENTIFICATION	CO IDEN				
1	FIELD LIGHTING POLE	1	F1					
1	FIELD LIGHTING POLE	1	F2					
1	FIELD LIGHTING POLE	1	F3					
1	FIELD LIGHTING POLE	1	F4					


FIELD LIGHTING WIRING

SCALE: N.T.S.

ADD ALTERNATE #1 & #2

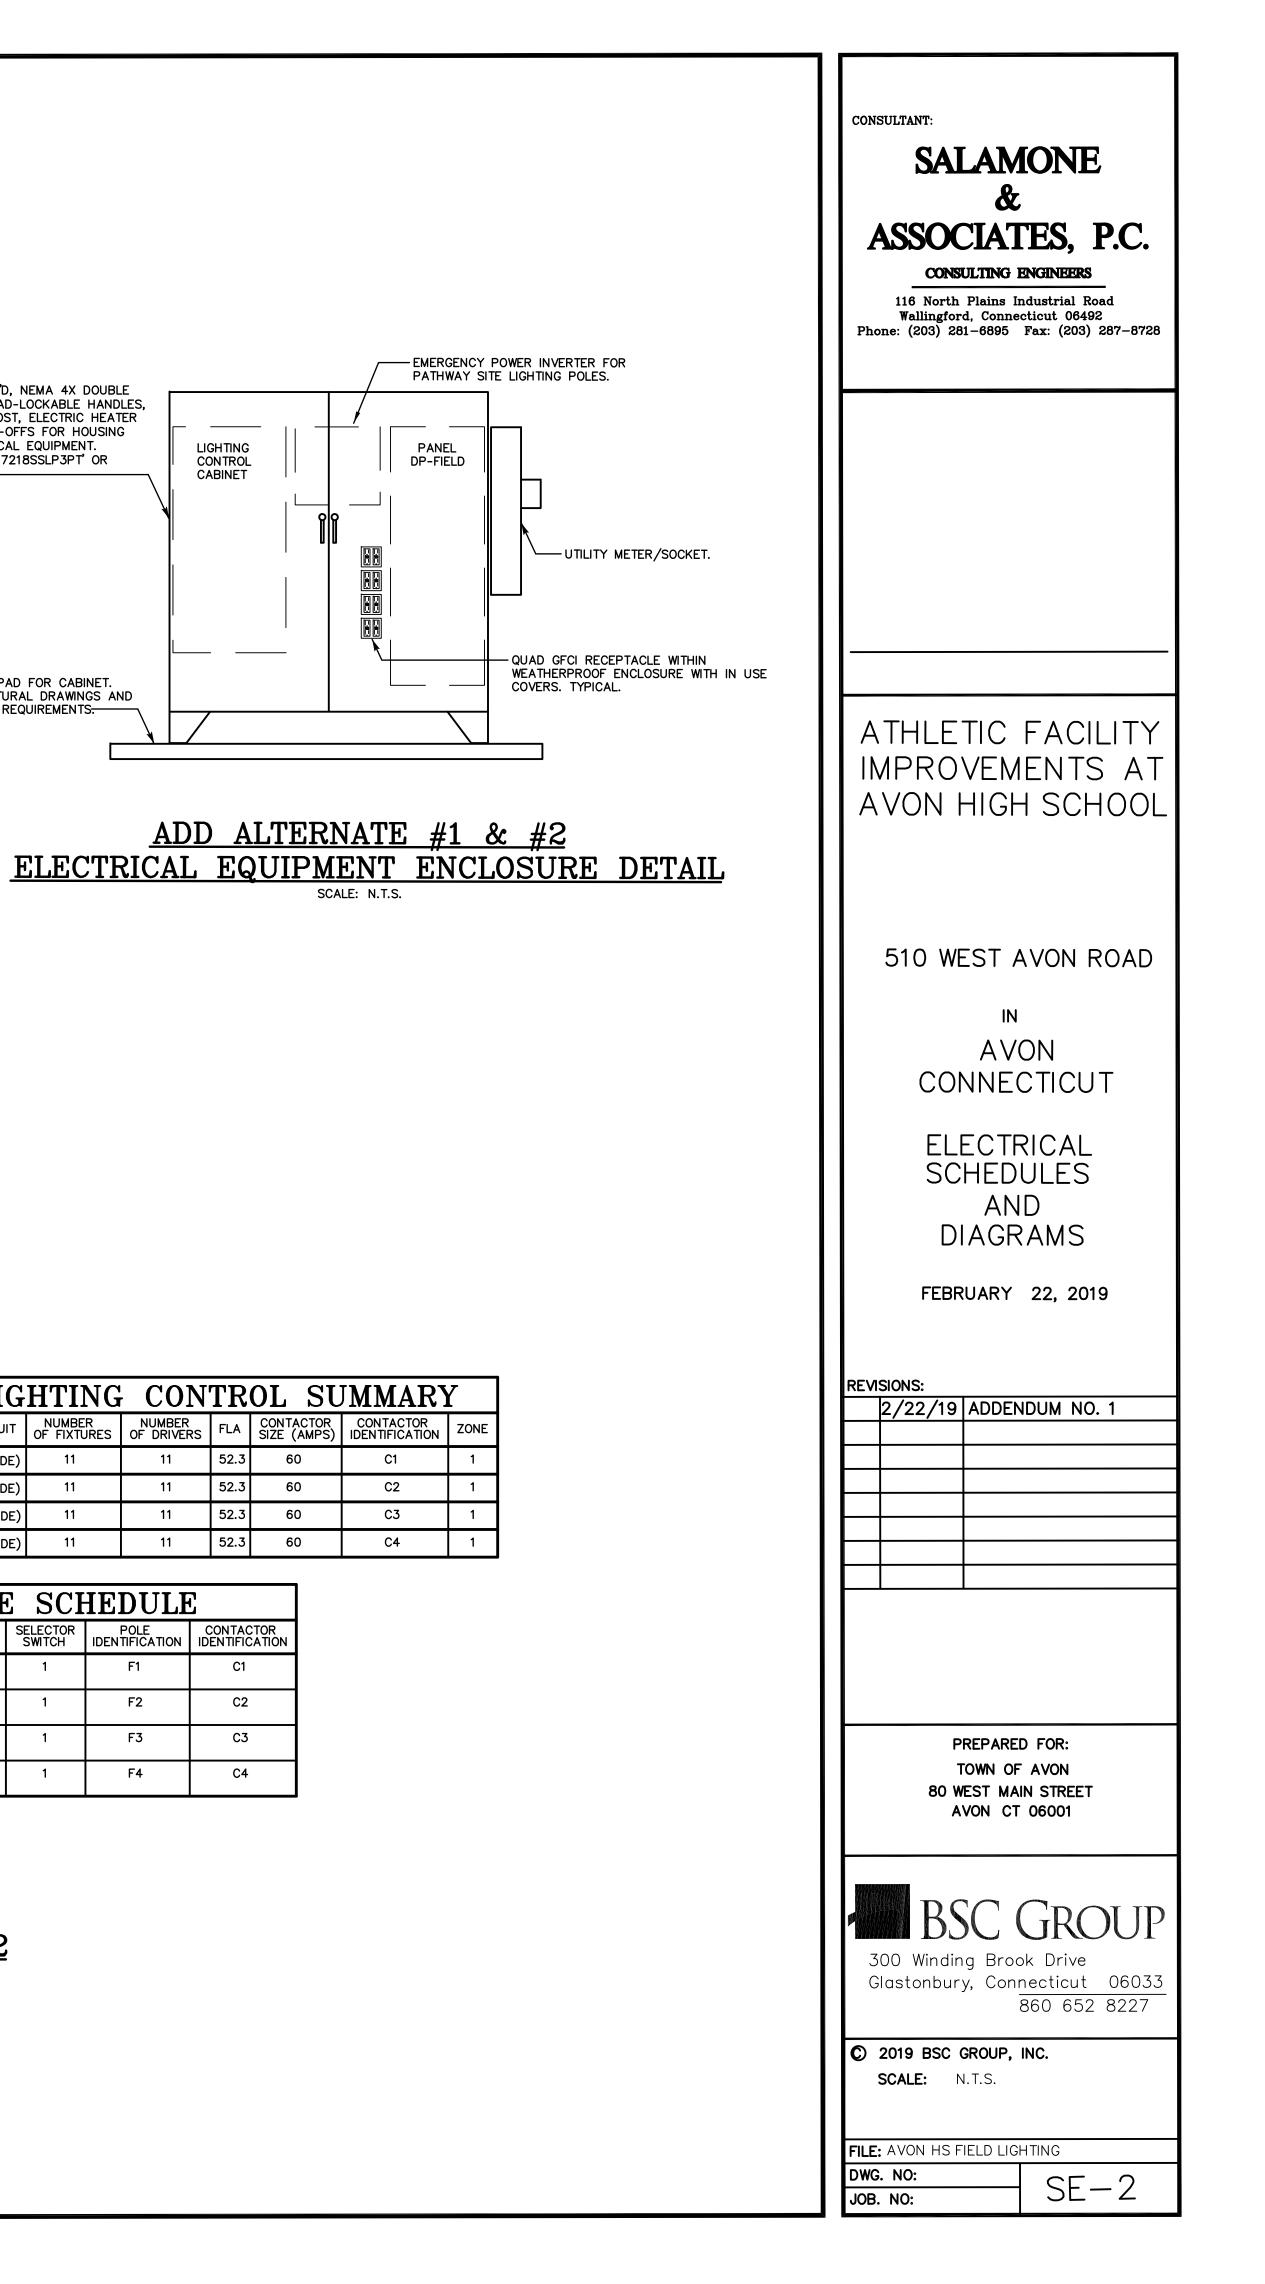

PANELBOARDClass:Short Circuit Rating (Min.): 65 K.A.I.C.DP-FIELDType:Remark:								:65 K.A.I.C.	LTG.				
	SERVICE	120/208 V	/olts	3 Phase	4 Wir	e	S/E Label: YES		CODE				
PANELBOARD CONFIGURATION		400 AMPEI Trim: SURF	PERE MAIN BUS Entrance: TOP/BOTTOM JRFACE Equipment Ground Bus: YES						'SL1'	27.5"X15" AND 14'-0 III DISTRIBI			
	MAIN		DA MAIN CIRCUIT BREAKER Enclosure: NEMA 1, LOCKABLE COVER : SEE RISER							BY ARCH			
	BRANCH CIRCUITS Branch Protective Devices: (MOLDED CASE CIRCUIT BREAKERS)								'SL2'	AND 14'-0 TYPE II DI			
Circ No	Circuit (Designation	KVA Load	Pole	Trip Amps	Frame Amps	Wire (min.)	See Remark		COLOR BY			
1	LIGHT POLE F1		23.5	3	70	100	SEE DRAWINGS						
2	LIGHT POLE F2		23.5	3	70	100	SEE DRAWINGS		1				
3			-	1	-	-			1				
4			-	-	-	-			1				
5			-	-	-	-			1				
6			-	-	-	-							
7	LIGHT POLE F3		23.5	3	70	100	SEE DRAWINGS		1				
8	LIGHT POLE F4		23.5	3	70	100	SEE DRAWINGS		1				
9			-	-	_	-			1				
10			-	1	-	-			1				
11			-	-	-	-			1				
12			-	-	-	-			1				
13	EXIST CONCESS	SION PANEL	10.0	2	90	100	EXISTING						
14	SCOREBOARD		1.6	1	20	100	SEE DRAWINGS						
15			-	-	-	-							
16	SCOREBOARD		1.6	1	20	100	SEE DRAWINGS						
17			-	-	-	-							
18	RECEPT - SCO		0.2	1	20	100	SEE DRAWINGS		1				
19	PATHWAY LIGH		0.3 0.5	1	20	100	1"C, 3-#10 AWG		1				
20		SHED LIGHTING & RECEPT		1	20	100	1"C, 3-#10 AWG		DP(
21	GFCI QUAD RE		0.4	1	20	100	1/2°C, 3-#12 AWG		PROVIDE TA PROOF MOL				
22	GFCI QUAD RE		0.4	1	20	100	1/2°C, 3-#12 AWG		BOL	_TS AND			
23	GFCI QUAD RE		0.4	1	20	100	1/2°C, 3-#12 AWG			RDWARE			
24	GFCI QUAD RE		0.4	1	20	100	1/2"C, 3-#12 AWG		1				
25 26	CONV RECEPT		1.2	1	20	100	SEE DRAWINGS						
20	LTG PANEL CO		1.2 1.6	1	20 20	100 100	SEE DRAWINGS 1/2"C, 3-#12 AWG		_				
27	PREPARED SPA		1.0	1	- 20	100	1/2 C, 3-#12 AWG						
29	PREPARED SPA		-	1	-	100							
30	PREPARED SPA		-	1	-	100							
31	PREPARED SPA		-	1	_	100			1				
32	SPD	. –	-	1	30	100			1				
33	PREPARED SPA	\CE	-	1	-	100							
34			-	-	_	-							
35	PREPARED SPA	\CE	-	1	_	100							
36			-	-	-	-							
		TOTAL	113.8						1				

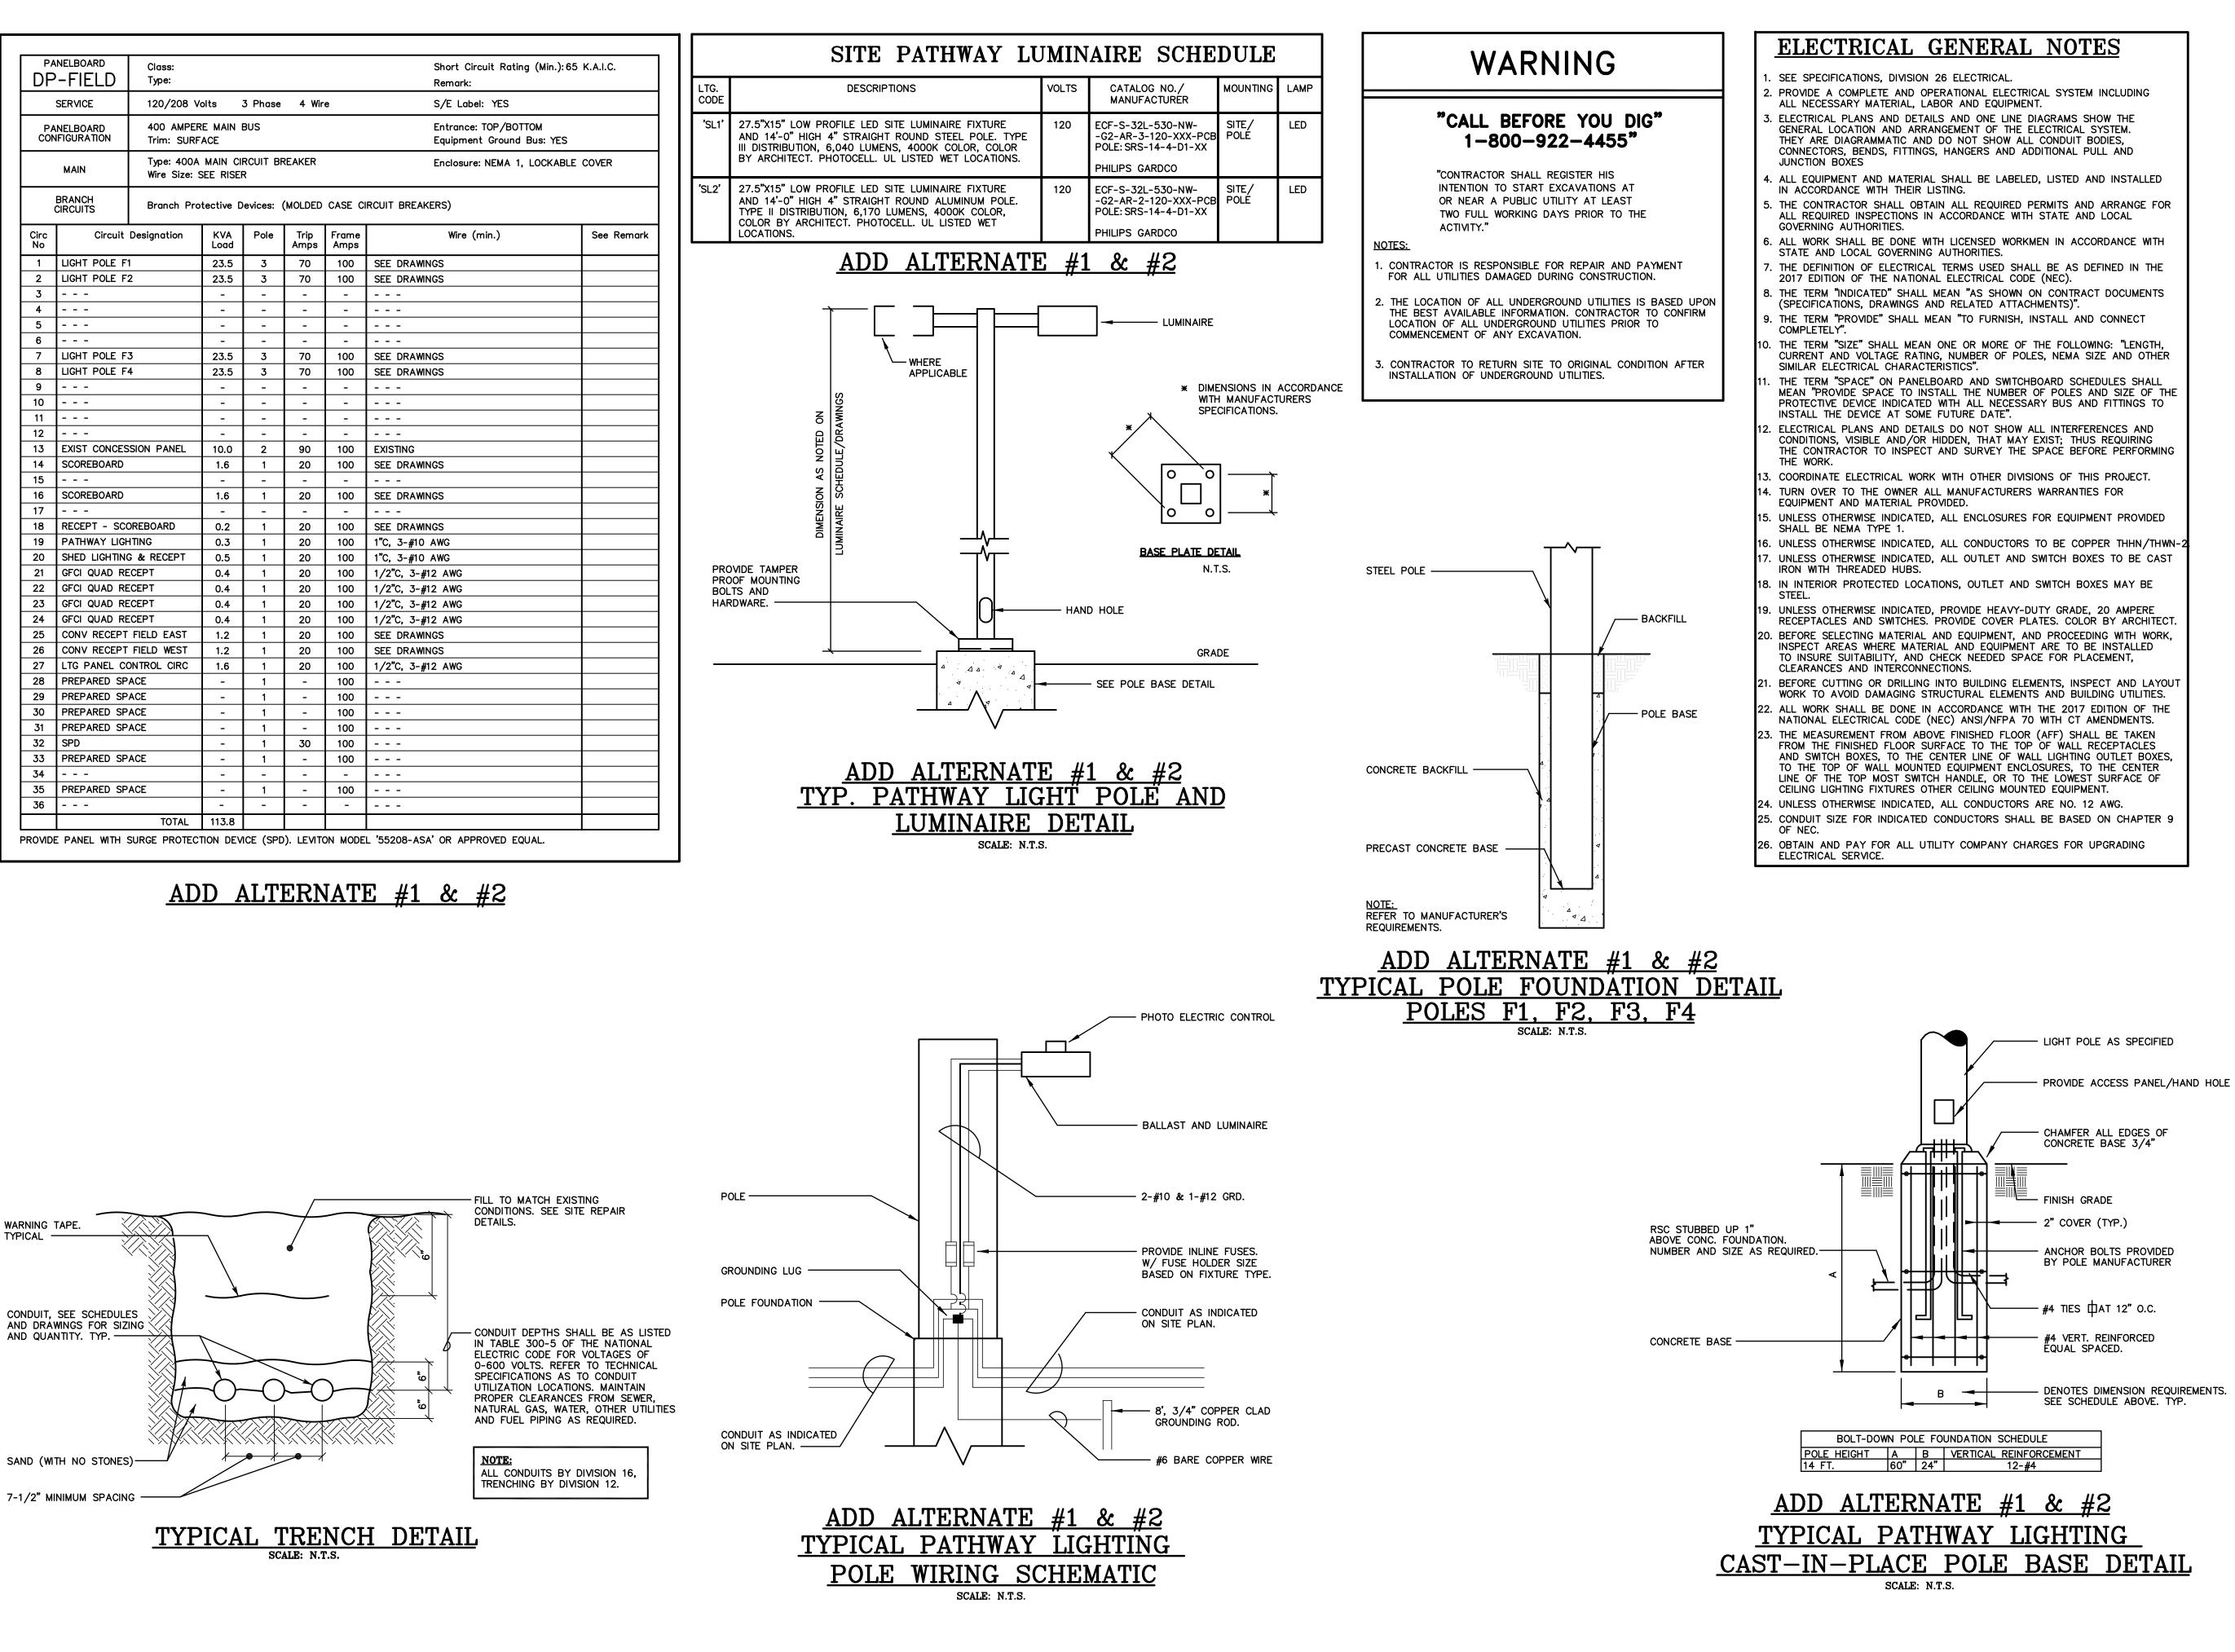

CONSULTANT:
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ATHLETIC FACILITY
AVON HIGH SCHOOL
510 WEST AVON ROAD
in AVON
CONNECTICUT
ELECTRICAL DETAILS, SYMBOLS
NOTES AND ABBREVIATIONS
FEBRUARY 22, 2019
REVISIONS:
2/22/19 ADDENDUM NO. 1
PREPARED FOR:
TOWN OF AVON 80 WEST MAIN STREET AVON CT 06001
300 Winding Brook Drive Glastonbury, Connecticut 06033 860 652 8227
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FILE: AVON HS FIELD LIGHTING

DWG. NO:

JOB. NO:

SE-3